2. FLAG OR FENCE CLEARING LIMITS.

3. INSTALL CATCH BASIN PROTECTION, IF REQUIRED.

4. GRADE AND INSTALL CONSTRUCTION ENTRANCE(S).

5. INSTALL PERIMETER PROTECTION (SILT FENCE, BRUSH BARRIER, ETC.)

6. CONSTRUCT SEDIMENT POND(S) AND/OR TRAP(S).

1. CONSTRUCT SURFACE WATER CONTROLS (INTERCEPTOR DIKES, PIPE SLOPE DRAINS, ETC.) SIMULTANEOUSLY WITH CLEARING AND GRADING FOR PROJECT

8. MAINTAIN TESC MEASURES IN ACCORDANCE WITH CITY STANDARDS AND MANUFACTURER'S RECOMMENDATIONS.

9. RELOCATE SURFACE WATER CONTROLS OR TESC MEASURES, OR INSTALL NEW MEASURES SO THAT AS SITE CONDITIONS CHANGE, THE TESC IS ALWAYS IN ACCORDANCE WITH THE CITY OF YARROW POINT TEMPORARY EROSION AND SEDIMENTATION CONTROL REQUIREMENTS.

10. COVER ALL AREAS THAT WILL BE UN-WORKED FOR MORE THAN TWO DAYS DURING THE WET SEASON (OCT. 1 TO APRIL 30) OR SEVEN DAYS DURING THE DRY SEASON (MAY I TO SEPT. 30) WITH STRAW, WOOD FIVER MULCH, COMPOST, PLASTIC SHEETING, OR EQUIVALENT.

II. STABILIZE ALL AREAS WITHIN SEVEN DAYS OF REACHING FINAL GRADE.

12. SEED OR SOD ANY AREAS TO REMAIN UN-WORKED FOR MORE THAN 30 DAYS.

13. UPON COMPLETION OF THE PROJECT, STABILIZE ALL DISTURBED AREAS AND REMOVE TESC MEASURES IF AFFROPRIATE.

PROVIDE STRAW OR PLASTIC COVER TO ANY EXPOSED SOILS THROUGH OUT THE CONSTRUCTION CYCLE.

STANDARD TESC PLAN NOTES:

<u>EXIST. LOT COVERAGE SURFACE</u>

EXIST. DRIVING SURFACE

PROPOSED LOT COVERAGE

MAXIMUM LOT COVERAGE

TOTAL LOT COVERAGE

LOT AREA

MAIN STRUCTURE W/ OVERHANGS - 4,372#

OFFICE ADDITION W/ OVERHANGS - 191#

- 2.198#

- I7,854#

- 7,142 *(40%)*

- 6,761/17,854= 37.9%

<u>HARDSCAPE SURFACE:</u>

TOTAL HARDSCAPE

LOT AREA

EXIST. PORCHES & PATIOS

PROPOSED HARDSCAPE

MAXIMUM HARDSCAPE

EXIST. ROCKERIES & R/R TIES

- 1,285#

- 80#

- 1,365#

- 17,854#

- 2.1% +9% = 11.1%

- 1,365/17,854= 7.7%

. APPROVAL OF THIS TEMPORARY EROSION AND SEDIMENTATION CONTROL (TESC) PLAN DOES NOT CONSTITUTE AN APPROVAL OF PERMANENT ROAD

2. THE IMPLEMENTATION OF THESE TESC PLANS AND THE CONSTRUCTION, MAINTENANCE, REPLACEMENT, AND UPGRADING OF THESE TESC FACILITIES IS THE RESPNSIBILITY OF THE OWNER/AGENT AND/OR THEIR CONTRACTOR UNTIL ALL CONSTRUCTION IS APPROVED.

3. THE BOUNDARIES OF THE CLEARING LIMITS SHOWN ON THIS PLAN SHALL BE CLEARLY FLAGGED BY A CONTINUOUS LENGTH OF SURVEY TAPE (OR FENCING, IF REQUIRED) PRIOR TO CONSTRUCTION. DURING THE CONSTRUCTION PERIOD, NO DISTURBANCE BEYOND THE CLEARING LIMITS SHALL BE PERMITTED. THE CLEARING LIMITS SHALL BE MAINTAINED BY THE OWNER/AGENT AND/OR THEIR CONTRACTOR FOR THE DURATION OF CONSTRUCTION.

4. THE TESC FACILITIES SHOWN ON THIS PLAN MUST BE CONSTRUCTED PRIOR TO OR IN CONJUNCTION WITH ALL CLEARING AND GRADING SO AS TO ENSURE THAT THE TRANSPORT OF SEDIMENT TO SURFACE WATERS, DRAINAGE SYSTEMS, AND ADJACENT PROPERTIES IS MINIMIZED.

5. THE TESC FACILITIES SHOWN ON THIS PLAN ARE THE MINIMUM REQUIREMENTS FOR ANTICIPATED SITE CONDITIONS. DURING THE CONSTRUCTION PERIOD, THESE TESC FACILITIES SHALL BE UPGRADED AS NEEDED FOR UNEXPECTED STORM EVENTS AND MODIFIED TO ACCOUNT CHANGING SITE CONDITIONS (E.G., ADDITIONAL BE APPPLIED AT A MINIMUM THICKNESS OF 2 TO 3 INCHES. SUMP PUMPS, RELOCATION OF DITCHES, HAY BALES AND SILT FENCES, ETC.).

6. THE TESC FACILITIES SHALL BE INSPECTED DAILY BY THE OWNER/AGENT AND/OR THEIR CONTRACTOR AND MAINTAINED TO ENSURE CONTINUED PROPER FUNCTIONING. WRITTEN RECORDS SHALL BE KEPT OF WEEKLY REVIEWS OF THE TESC FACILITIES DURING THE WET SEASON (OCT. I TO APRIL 30) AND OF MONTHLY REVIEWS DURING THE DRY SEASON (MAY I TO SEPT. 30).

7. ANY AREAS OF EXPOSED SOILS, INCLUDING ROADWAY EMBANKMENTS, THAT WILL NOT BE DISTURBED FOR TWO DAYS DURING THE WET SEASON (OCT. I TO APRIL 30) OR SEVEN DAYS DURING THE DRY SEASON (MAY I TO SEPT. 30) SHALL BE IMMEDIATELY STABILIZED WITH APPROVED TESC METHODS (E.G., SEEDING, MULCHING, PLASTIC COVERING, ETC.)

8. ANY AREA NEEDING TESC MEASURES THAT DO NOT REQUIRE IMMEDIATE ATTENTION SHALL BE ADDRESSED WITHIN (15) DAYS.

9. THE TESC FACILITIES ON INACTIVE SITES SHALL BE INSPECTED AND MAINTAINED A MINIMUM OF ONCE A MONTH OR WITHIN FORTY-EIGHT (48) HOURS FOLLOWING A STORM


10. AT NO TIME SHALL MORE THAN ONE (1) FOOT OF SEDIMENT BE ALLOWED TO ACCUMULATE WITHIN A CATCH BASIN. ALL CATCH BASINS AND CONVEYANCE LINES SHALL BE CLEANED PRIOR TO FINAL GRADING AND/OR PAVING. THE CLEANING OPERATION SHALL NOT FLUSH SEDIMENT-LADEN WATER INTO THE DOWNSTREAM

II. STABILIZED CONSTRUCTION ENTRANCES AND ROADS SHALL BE INSTALLED AT THE BEGINNING OF CONSTRUCTION AND MAINTAINED FOR THE DURATION OF THE PROJECT. ADDITIONAL MEASURES, SUCH AS WASH PADS AND SEDIMENT TRAPS, MAY BE REQUIRED TO ENSURE THAT ALL PAVED AREAS ARE KEPT CLEAN FOR THE DURATION OF THE PROJECT.

12. ANY PERMANENT FLOW CONTROL FACILITY USED AS TEMPORARY SETTLING BASIN SHALL BE MODIFIED WITH THE NECESSARY TEMPORARY EROSION CONTROL MEASURES AND SHALL PROVIDE ADEQUATE STORAGE CAPACITY.


13. WHERE STRAW MULCH FOR TEMPORARY EROSION CONTROL IS REQUIRED, IT SHALL

14. PRIOR TO THE BEGINNING OF THE WET SEASON (OCT. 1) ALL DISTURBED AREAS SHALL BE REVIEWED TOIDENTIFY WHICH ONES CAN BE SEEDED IN PREPARATION FOR THE WINTER RAINS. DISTURBED AREAS SHALL BE SEEDED WITHIN ONE WEEK OF THE BEGINNING OF THE WET SEASON. THE CITY CAN REQUIRE SEEDING OF ADDITIONAL AREAS IN ORDER TO PROTECT SURFACE WATERS, ADJACENT PROPERTIES, OR DRAINAGE FACILITIES.

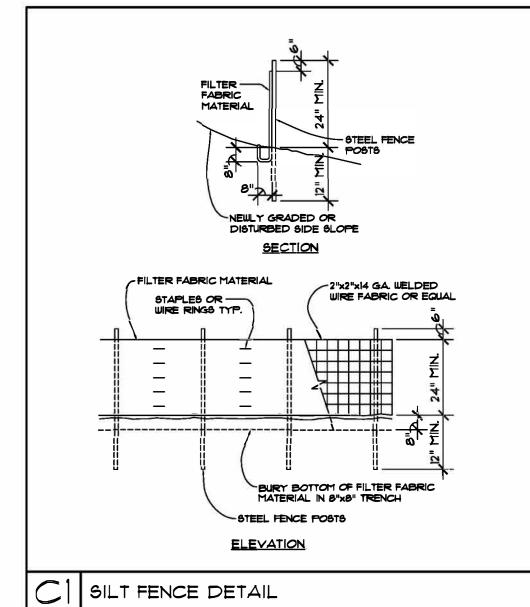

20

SUBJECT PROPERTY TAX PARCEL NO. 294890-0012

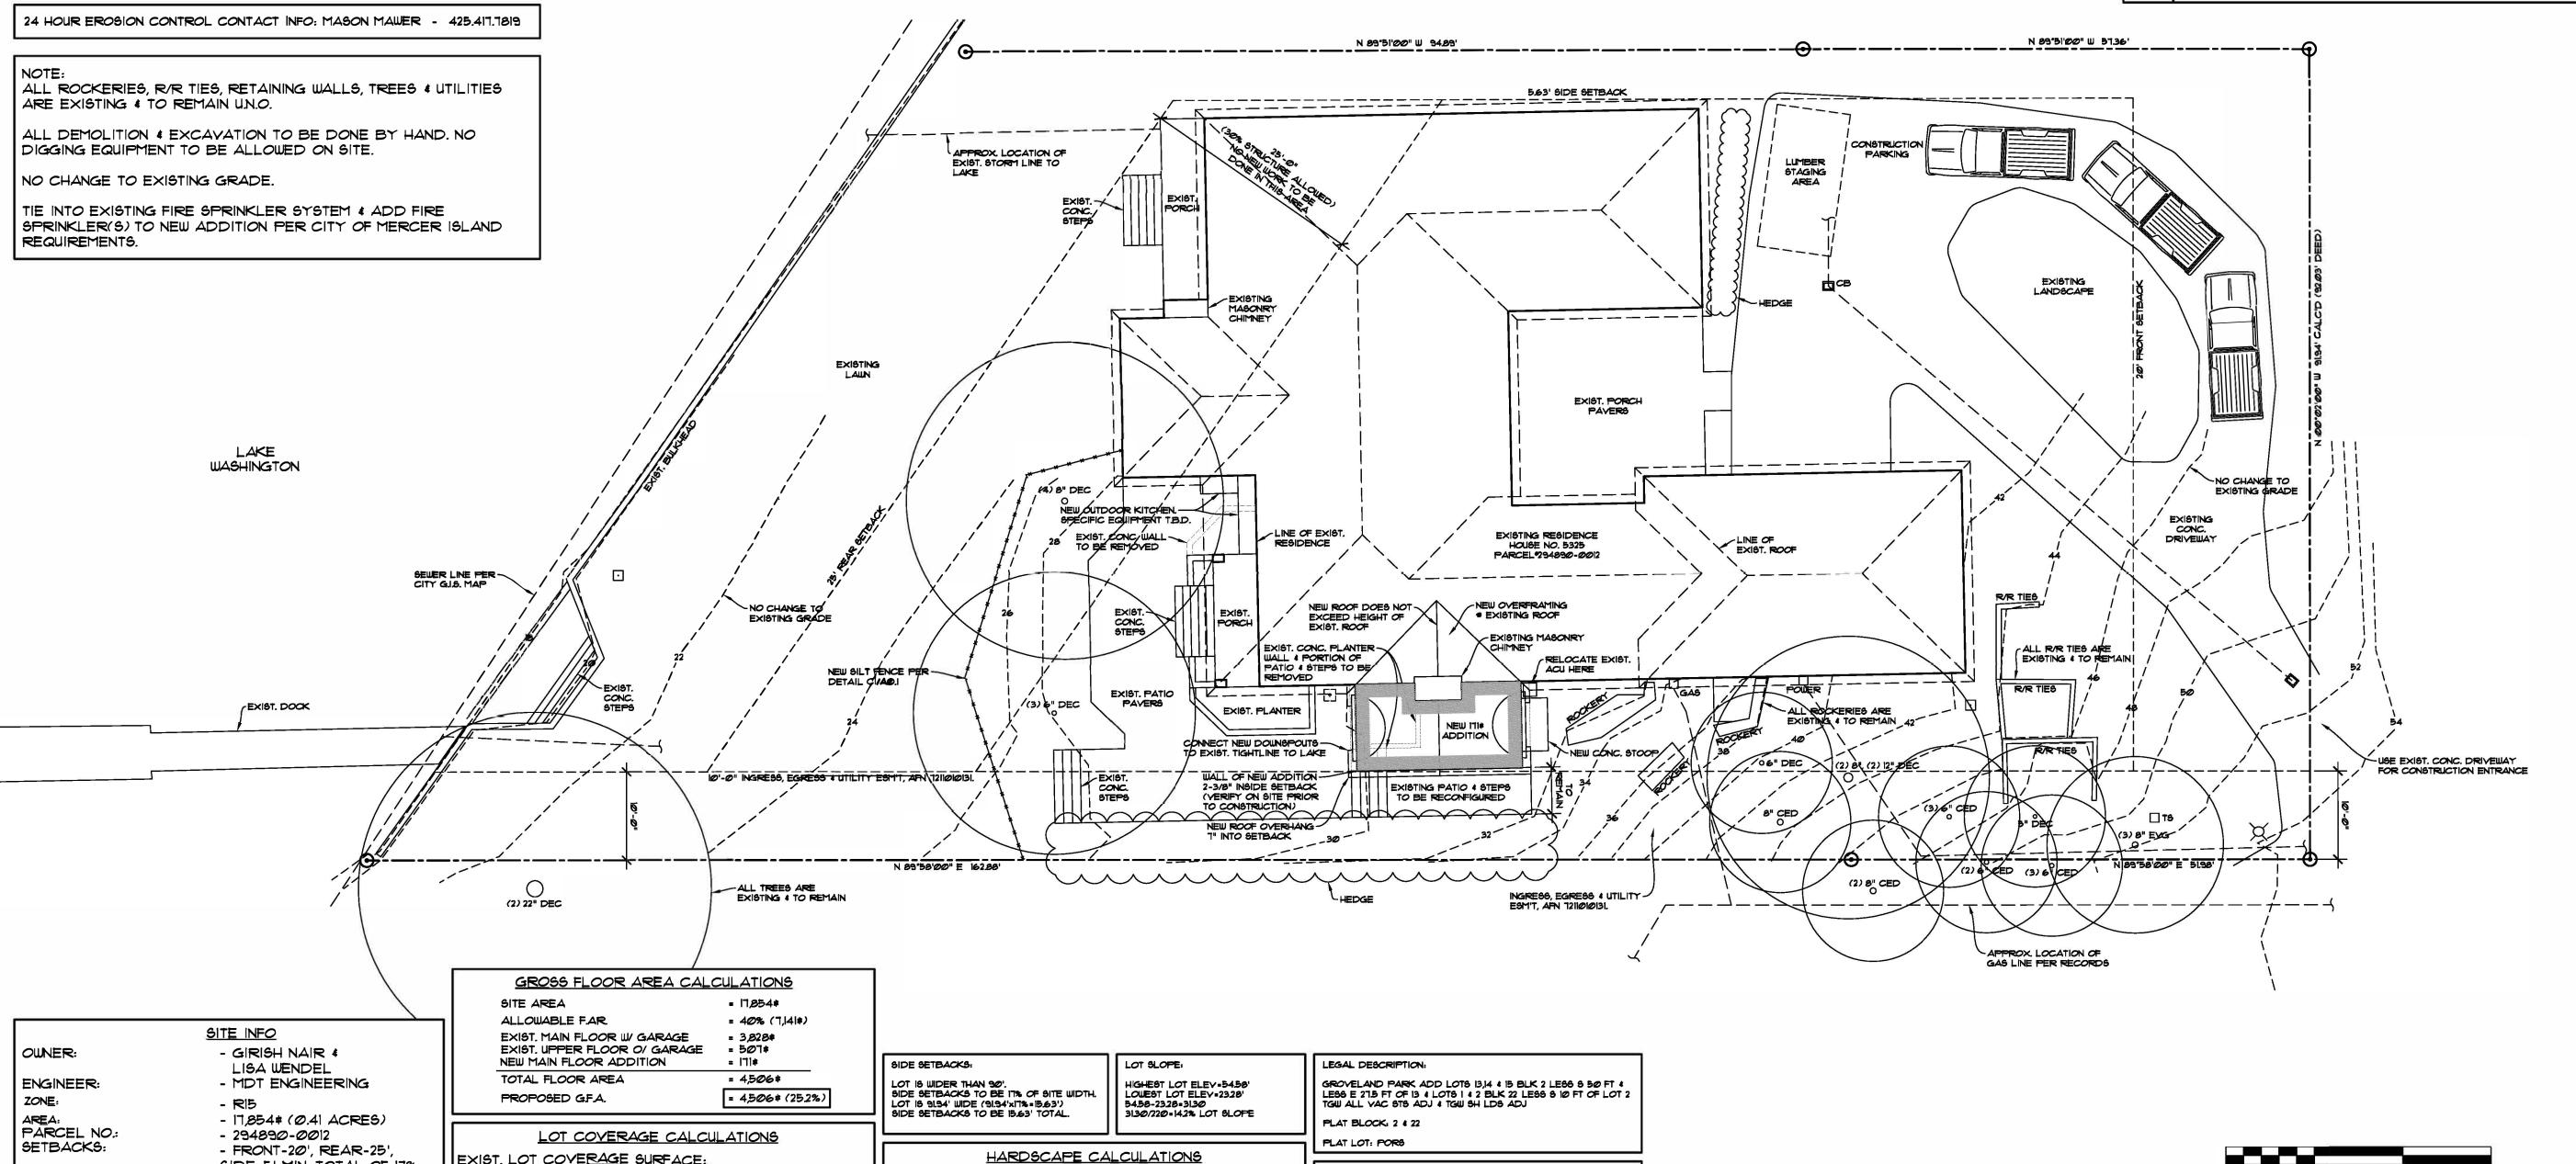

SHEET INDEX:

A2 - MAIN FLOOR DEMO PLAN

A3 - MAIN FLOOR PLAN

A4 - ROOF FRAMING PLAN

AI - FOUNDATION & MAIN FLOOR FRAMING PLAN

A5 - ENLARGED ROOF FRAMING PLAN (1/2" = 1'-0")

AT - SECTIONS & WINDOW/DOOR SCHEDULE

AØ.1 - SITE PLAN

A6 - ELEVATIONS

SITE PLAN


5325 WEST MERCER WAY

MERCER ISLAND, WA 98040

SCALE: |" = 10'

NORTH

Hand Hand Û _

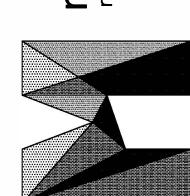

S **ii**fe

E ADDITION T MERCER WAY LAND, WA 98040 NAIR-WENDEL FICE /EST I R ISL/

JOB NO: 19-022 DATE: 8104120 DRWN. BY:MM REVISED:

SHEET NO.

HEIGHT LIMIT:

LOT SLOPE:

HARDSCAPE:

GROSS FLOOR AREA:

REQUIRED LANDSCAPE

LOT COVERAGE:

SIDE-5' MIN. TOTAL OF 17%

- 40% (BUILDING & VEHICLE

OF LOT WIDTH

- 4*0*% (7.142#)

- 60%

- 30' ABOVE A.B.E.

DRIVING SURFACE)

- LESS THAN 15%

- +9% (626#)

LEGAL DESCRIPTION

THAT PORTION OF VACATED BLOCKS 2 AND 22, GROVELAND PARK, ACCORDING TO THE PLAT THEREOF, RECORDED IN VOLUME 8 OF PLATS PAGE 36, IN KING COUNTY, WASHINGTON, AND VACATED STREETS ADJOINING, DESCRIBED AS FOLLOWS:

BEGINNING AT THE INTERSECTION OF THE WEST LINE OF LOT 8 OF SAID BLOCK 2 WITH A LINE 190.00 FEET NORTH OF, AND PARALLEL TO, THE CENTERLINE OF BONNEY STREET AS SHOWN ON SAID PLAT;

THENCE SOUTH 89°59'39" WEST ALONG SAID PARALLEL LINE 187.50 FEET TO THE TRUE POINT OF BEGINNING; THENCE NORTH 00°00'21" WEST 92.03 FEET TO THE NORTH LINE OF VACATED BORDER STREET, AS SHOWN ON SAID PLAT;

THENCE NORTH 89°50'25" WEST ALONG SAID NORTH LINE TO THE GOVERNMENT MEANDER LINE;

THENCE SOUTHERLY ALONG SAID MEANDER LINE TO A POINT WHICH BEARS SOUTH 89°59'39" WEST FROM THE TRUE POINT OF BEGINNING;

THENCE NORTH 89°59'39" EAST TO THE TRUE POINT OF BEGINNING;

TOGETHER WITH THE SHORELANDS OF THE 2ND CLASS ADJOINING;

TOGETHER WITH AN EASEMENT FOR INGRESS AND EGRESS OVER A STRIP OF LAND 10 FEET IN WIDTH, THE SOUTH LINE OF WHICH IS DESCRIBED AS FOLLOWS: THENCE NORTH 89°59'39" EAST TO THE WEST LINE OF LOT 8 IN SAID BLOCK 2;

TOGETHER WITH AN EASEMENT FOR INGRESS AND EGRESS DESCRIBED AS FOLLOWS:

THE WEST 30 FEET OF LOTS 8 AND 23 IN SAID BLOCK 2 AND THE NORTH 30 FEET OF THAT PORTION OF VACATED BONNY STREET LYING BETWEEN THE WEST LIFE OF SAID LOT 23, BLOCK 2, PRODUCED SOUTH AND THE WESTERLY LINE OF WEST MERCER WAY; AND, THAT PORTION OF VACATED ANDERSON AVENUE AND SAID BLOCK 2 WITHIN THE FOLLOWING DESCRIBED TRACT:

BEGINNING AT A POINT ON THE SOUTHERLY MARGIN OF THE NORTH 30 FEET OF THE VACATED BONNEY STREET, 70 FEET WEST OF THE WESTERLY MARGIN OF WEST MERCER WAY; THENCE EAST ALONG SAID SOUTHERLY MARGIN TO THE WESTERLY MARGIN OF WEST MERCER WAY; THENCE NORTHERLY ALONG THE WEST MARGIN OF WEST MERCER WAY A DISTANCE OF 110 FEET; AND THENCE IN A STRAIGHT LINE TO THE POINT OF BEGINNING; EXCEPT THAT PORTION OF THE WEST 30 FEET OF SAID LOT 8, BLOCK 2, LYING NORTHERLY OF A LINE 200 FEET NORTH OF AND PARALLEL TO THE CENTERLINE OF VACATED BONNEY STREET IN SAID PLAT.

BASIS OF BEARINGS

N 89°58'00" E BETWEEN SURVEY MONUMENTS FOUND ON THE SOUTH LINE OF THE NORTH HALF OF VACATED BONNEY ST. AS SHOWN HEREON AND PER R1 & R2.

REFERENCES

- R1 SHORT PLAT MI 79-03-09, RECORDED IN BOOK 23 OF SURVEYS, PAGE 100, RECORDS OF KING COUNTY, WASHINGTON. R2 UNRECORDED SURVEY BY M.W. MARSHALL LAND SURVEYING,
- JOB NO. 5028 R3 SUN WEST ESTATES, RECORDED IN VOLUME 93 OF PLATS, PAGE 35, RECORDS OF KING COUNTY, WASHINGTON.

VERTICAL DATUM

NAVD(88) PER GPS OBSERVATIONS.

SURVEYOR'S NOTES

- . THE TOPOGRAPHIC SURVEY SHOWN HEREON WAS PERFORMED IN FEBRUARY OF 2020. THE FIELD DATA WAS COLLECTED AND RECORDED ON MAGNETIC MEDIA THROUGH AN ELECTRONIC THEODOLITE. THE DATA FILE IS ARCHIVED ON DISC OR CD. WRITTEN FIELD NOTES MAY NOT EXIST. CONTOURS ARE SHOWN FOR CONVENIENCE ONLY. DESIGN SHOULD RELY ON SPOT ELEVATIONS.
- 2. ALL MONUMENTS SHOWN HEREON WERE LOCATED DURING THE COURSE OF THIS SURVEY UNLESS OTHERWISE NOTED.
- 3. THE TYPES AND LOCATIONS OF ANY UTILITIES SHOWN ON THIS DRAWING ARE BASED ON INFORMATION PROVIDED TO US, BY OTHERS OR GENERAL INFORMATION READILY AVAILABLE IN THE PUBLIC DOMAIN INCLUDING, AS APPLICABLE, IDENTIFYING MARKINGS PLACED BY UTILITY LOCATE SERVICES AND OBSERVED BY TERRANE IN THE FIELD. AS SUCH, THE UTILITY INFORMATION SHOWN ON THESE DRAWINGS ARE FOR INFORMATIONAL PURPOSES ONLY AND SHOULD NOT BE RELIED ON FOR DESIGN OR CONSTRUCTION PURPOSES; TERRANE IS NOT RESPONSIBLE OR LIABLE FOR THE ACCURACY OR COMPLETENESS OF THIS UTILITY INFORMATION. FOR THE ACCURATE LOCATION AND TYPE OF UTILITIES NECESSARY FOR DESIGN AND CONSTRUCTION, PLEASE CONTACT THE SITE OWNER AND THE LOCAL UTILITY LOCATE SERVICE (800-424-5555).
- 4. SUBJECT PROPERTY TAX PARCEL NO. 294890-0012.
- 5. THE PROPERTY DESCRIBED HEREON IS THE SAME AS THE PROPERTY DESCRIBED IN CHICAGO TITLE INSURANCE COMPANY, ORDER NO. 1372482, WITH AN EFFECTIVE DATE OF JANUARY 15, 2019 AND THAT ALL EASEMENTS, COVENANTS AND RESTRICTIONS REFERENCED IN SAID TITLE COMMITMENT OR APPARENT FROM A PHYSICAL INSPECTION OF THE PROPERTY OR OTHERWISE KNOWN TO ME HAVE BEEN PLOTTED HEREON OR OTHERWISE NOTED AS TO THEIR EFFECT ON THE PROPERTY.
- 6. FIELD DATA FOR THIS SURVEY WAS OBTAINED BY DIRECT FIELD MEASUREMENTS WITH A CALIBRATED ELECTRONIC 5-SECOND TOTAL STATION AND/OR SURVEY GRADE GPS OBSERVATIONS. ALL ANGULAR AND LINEAR RELATIONSHIPS ARE ACCURATE AND MEET THE STANDARDS SET BY WAC 332-130-090.

TOPOGRAPHIC & BOUNDARY SURVEY

SCHEDULE B ITEMS

1. EASEMENT AND THE TERMS AND CONDITIONS THEREOF: PURPOSE: WATER PIPELINE

AREA AFFECTED: THE SOUTHERLY 3 FEET OF SAID PREMISES RECORDED: MARCH 28, 1955 RECORDING NUMBER: 4555320 (DOCUMENT UNREADABLE)

SAID INSTRUMENT HAS BEEN MODIFIED BY INSTRUMENT RECORDED UNDER RECORDING NUMBER 7911260633. (PLOTTED)

SAID INSTRUMENT CONTAINS PROVISIONS FOR BEARING THE COST OF MAINTENANCE, REPAIR OR RECONSTRUCTION OF THE WATER PIPELINE

2. EASEMENT AND THE TERMS AND CONDITIONS THEREOF: GRANTEE: PUGET SOUND POWER & LIGHT COMPANY PURPOSE: ELECTRIC TRANSMISSION AND/OR DISTRIBUTION SYSTEM AREA AFFECTED: PORTION OF SAID PREMISES AND OTHER PROPERTY RECORDED: DECEMBER 13, 1940 RECORDING NUMBER: 3138760 (EASEMENT DESCRIPTION INCOMPLETE)

3. EASEMENT AND THE TERMS AND CONDITIONS THEREOF: GRANTEE: MERCER ISLAND SEWER DISTRICT

PURPOSE: SEWER PIPE LINE AREA AFFECTED: A 10-FOOT STRIP OF LAND ACROSS SECOND CLASS SHORELANDS RECORDED: MAY 20, 1965

RECORDING NUMBER: 5881465 (AS CONSTRUCTED, NOT PLOTTED)

4. EASEMENT PROVISIONS DISCLOSED BY INSTRUMENT AND THE TERMS AND CONDITIONS THEREOF: PURPOSE: INGRESS AND EGRESS AFFECTS: SOUTH 30 FEET

RECORDED: NOVEMBER 1, 1972 RECORDING NUMBER: 7211010131 (PLOTTED)

5. EASEMENT PROVISIONS DISCLOSED BY INSTRUMENT AND THE TERMS AND CONDITIONS THEREOF: PURPOSE: SIDE SEWER

AFFECTS: PORTION OF SAID PREMISES

RECORDED: NOVEMBER 1, 1972 RECORDING NUMBER: 7211010131 (EASEMENT AREA NOT DESCRIBED)

THE DESCRIPTION CONTAINED THEREIN IS NOT SUFFICIENT TO DETERMINE ITS EXACT LOCATION WITHIN THE PROPERTY HEREIN

SAID INSTRUMENT AS BEEN MODIFIED BY INSTRUMENTS RECORDED UNDER RECORDING NUMBERS 7908310133 (ADDS BENEFICIARIES), 8003040184 (CLARIFIES TERMS & CONDITIONS OF EASEMENT), AND 8007140383 (DOCUMENT NOT PROVIDED).

3. AGREEMENT AND THE TERMS AND CONDITIONS THEREOF: BETWEEN: DONNA BOUILLON AND: DOUGLAS DEFOREST AND DEBORAH DEFOREST RECORDED; JULY 5, 1974 RECORDING NUMBER: 7407050502 REGARDING: DECLARATION OF EASEMENT FOR USE AND MAINTENANCE OF DOCK (DOCK EASEMENT TERMINATED)

SAID AGREEMENT HAS BEEN MODIFIED BY AGREEMENT FOR TERMINATION OF EASEMENT RECORDED UNDER RECORDING NUMBER

7. DRIVEWAY EASEMENT AGREEMENT, INCLUDING THE TERMS AND PROVISIONS THEREOF: RECORDED: AUGUST 28, 2003 RECORDING NUMBER: 20030828003801 (PLOTTED)

LEGEND

FOUND CASED SURVEY MONUMENT XX FENCE (CHAIN LINK) FOUND CONCRETE MONUMENT ---- G---- GAS LINE FOUND IRON PIPE/REBAR & CAP FOUND NAIL/SHINER BUILDING

AIR CONDITIONING UNIT GAS METER

YARD LIGHT

RETAINING WALL CATCH BASIN (TYPE 1) TELEPHONE SENTRY

CONCRETE SURFACE $\sim\sim$ TREE (TYPE, SIZE)) HEDGE ROCKERY

EASEMENT LEGEND

ITEM 04 - INGRESS/EGRESS ESM'T, AFN 7211010131.

ASPHALT SURFACE


ITEM 01 - INGRESS, EGRESS,

DRAINATE & UTILITIES ESM'T, AFN ITEM 04 - INGRESS, EGRESS &

UTILITY ESM'T, AFN 7211010131.

ITEM 07 - DRIVEWAY EASEMENT, AFN 20030828003801

STEEP SLOPE/BUFFER DISCLAIMER: THE LOCATION AND EXTENT OF STEEP SLOPES SHOWN ON THIS DRAWING ARE FOR INFORMATIONAL PURPOSES ONLY AND CANNOT BE RELIED ON FOR DESIGN AND/OR CONSTRUCTION. THE PITCH, LOCATION, AND EXTENT ARE BASED SOLELY ON OUR GENERAL OBSERVATIONS ON SITE AND OUR CURSORY REVIEW OF READILY AVAILABLE PUBLIC DOCUMENTS; AS SUCH, TERRANE CANNOT BE LIABLE OR RESPONSIBLE FOR THE ACCURACY OR COMPLETENESS OF ANY STEEP SLOPE INFORMATION. ULTIMATELY, THE LIMITS AND EXTENT OF ANY STEEP SLOPES ASSOCIATED WITH ANY SETBACKS OR OTHER DESIGN OR CONSTRUCTION PARAMETERS MUST BE DISCUSSED AND APPROVED BY THE REVIEWING AGENCY BEFORE ANY CONSTRUCTION CAN OCCUR.

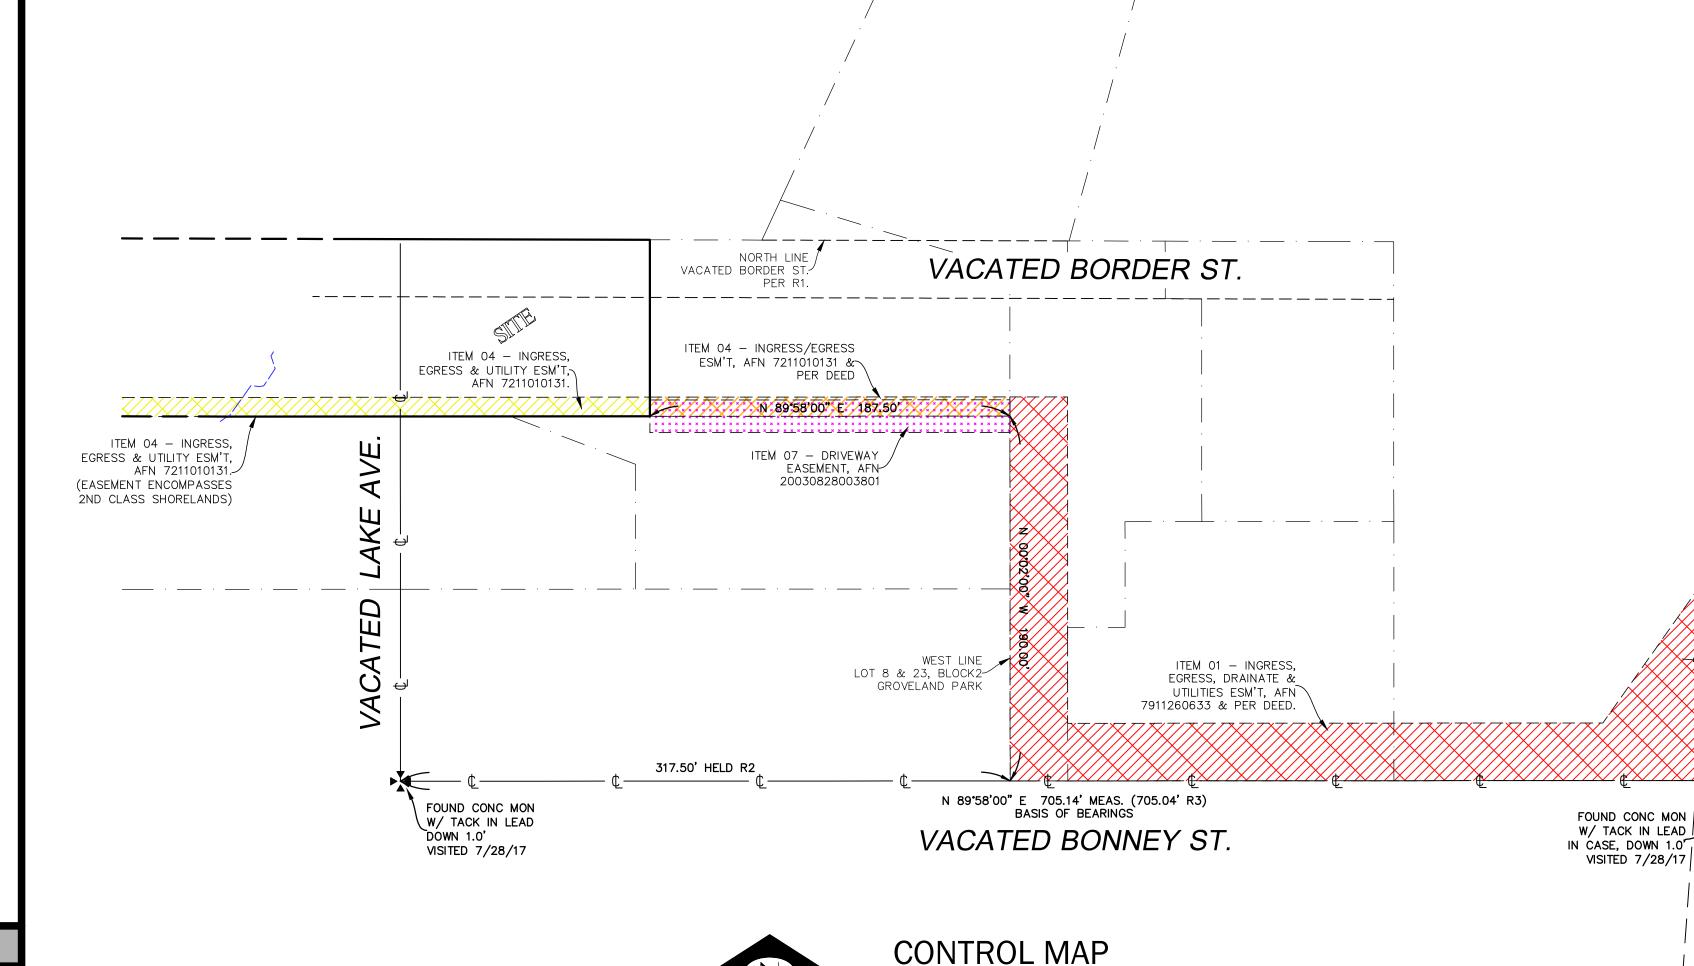



BOUND,

∞


ROW [

192242 02/12/2020 JGM/RLS REVISION HISTORY SHEET NUMBER

1 OF 2


VICINITY MAP N.T.S. 325 West Mercer Way

JOB NUMBER: DRAFTED BY CHECKED BY:

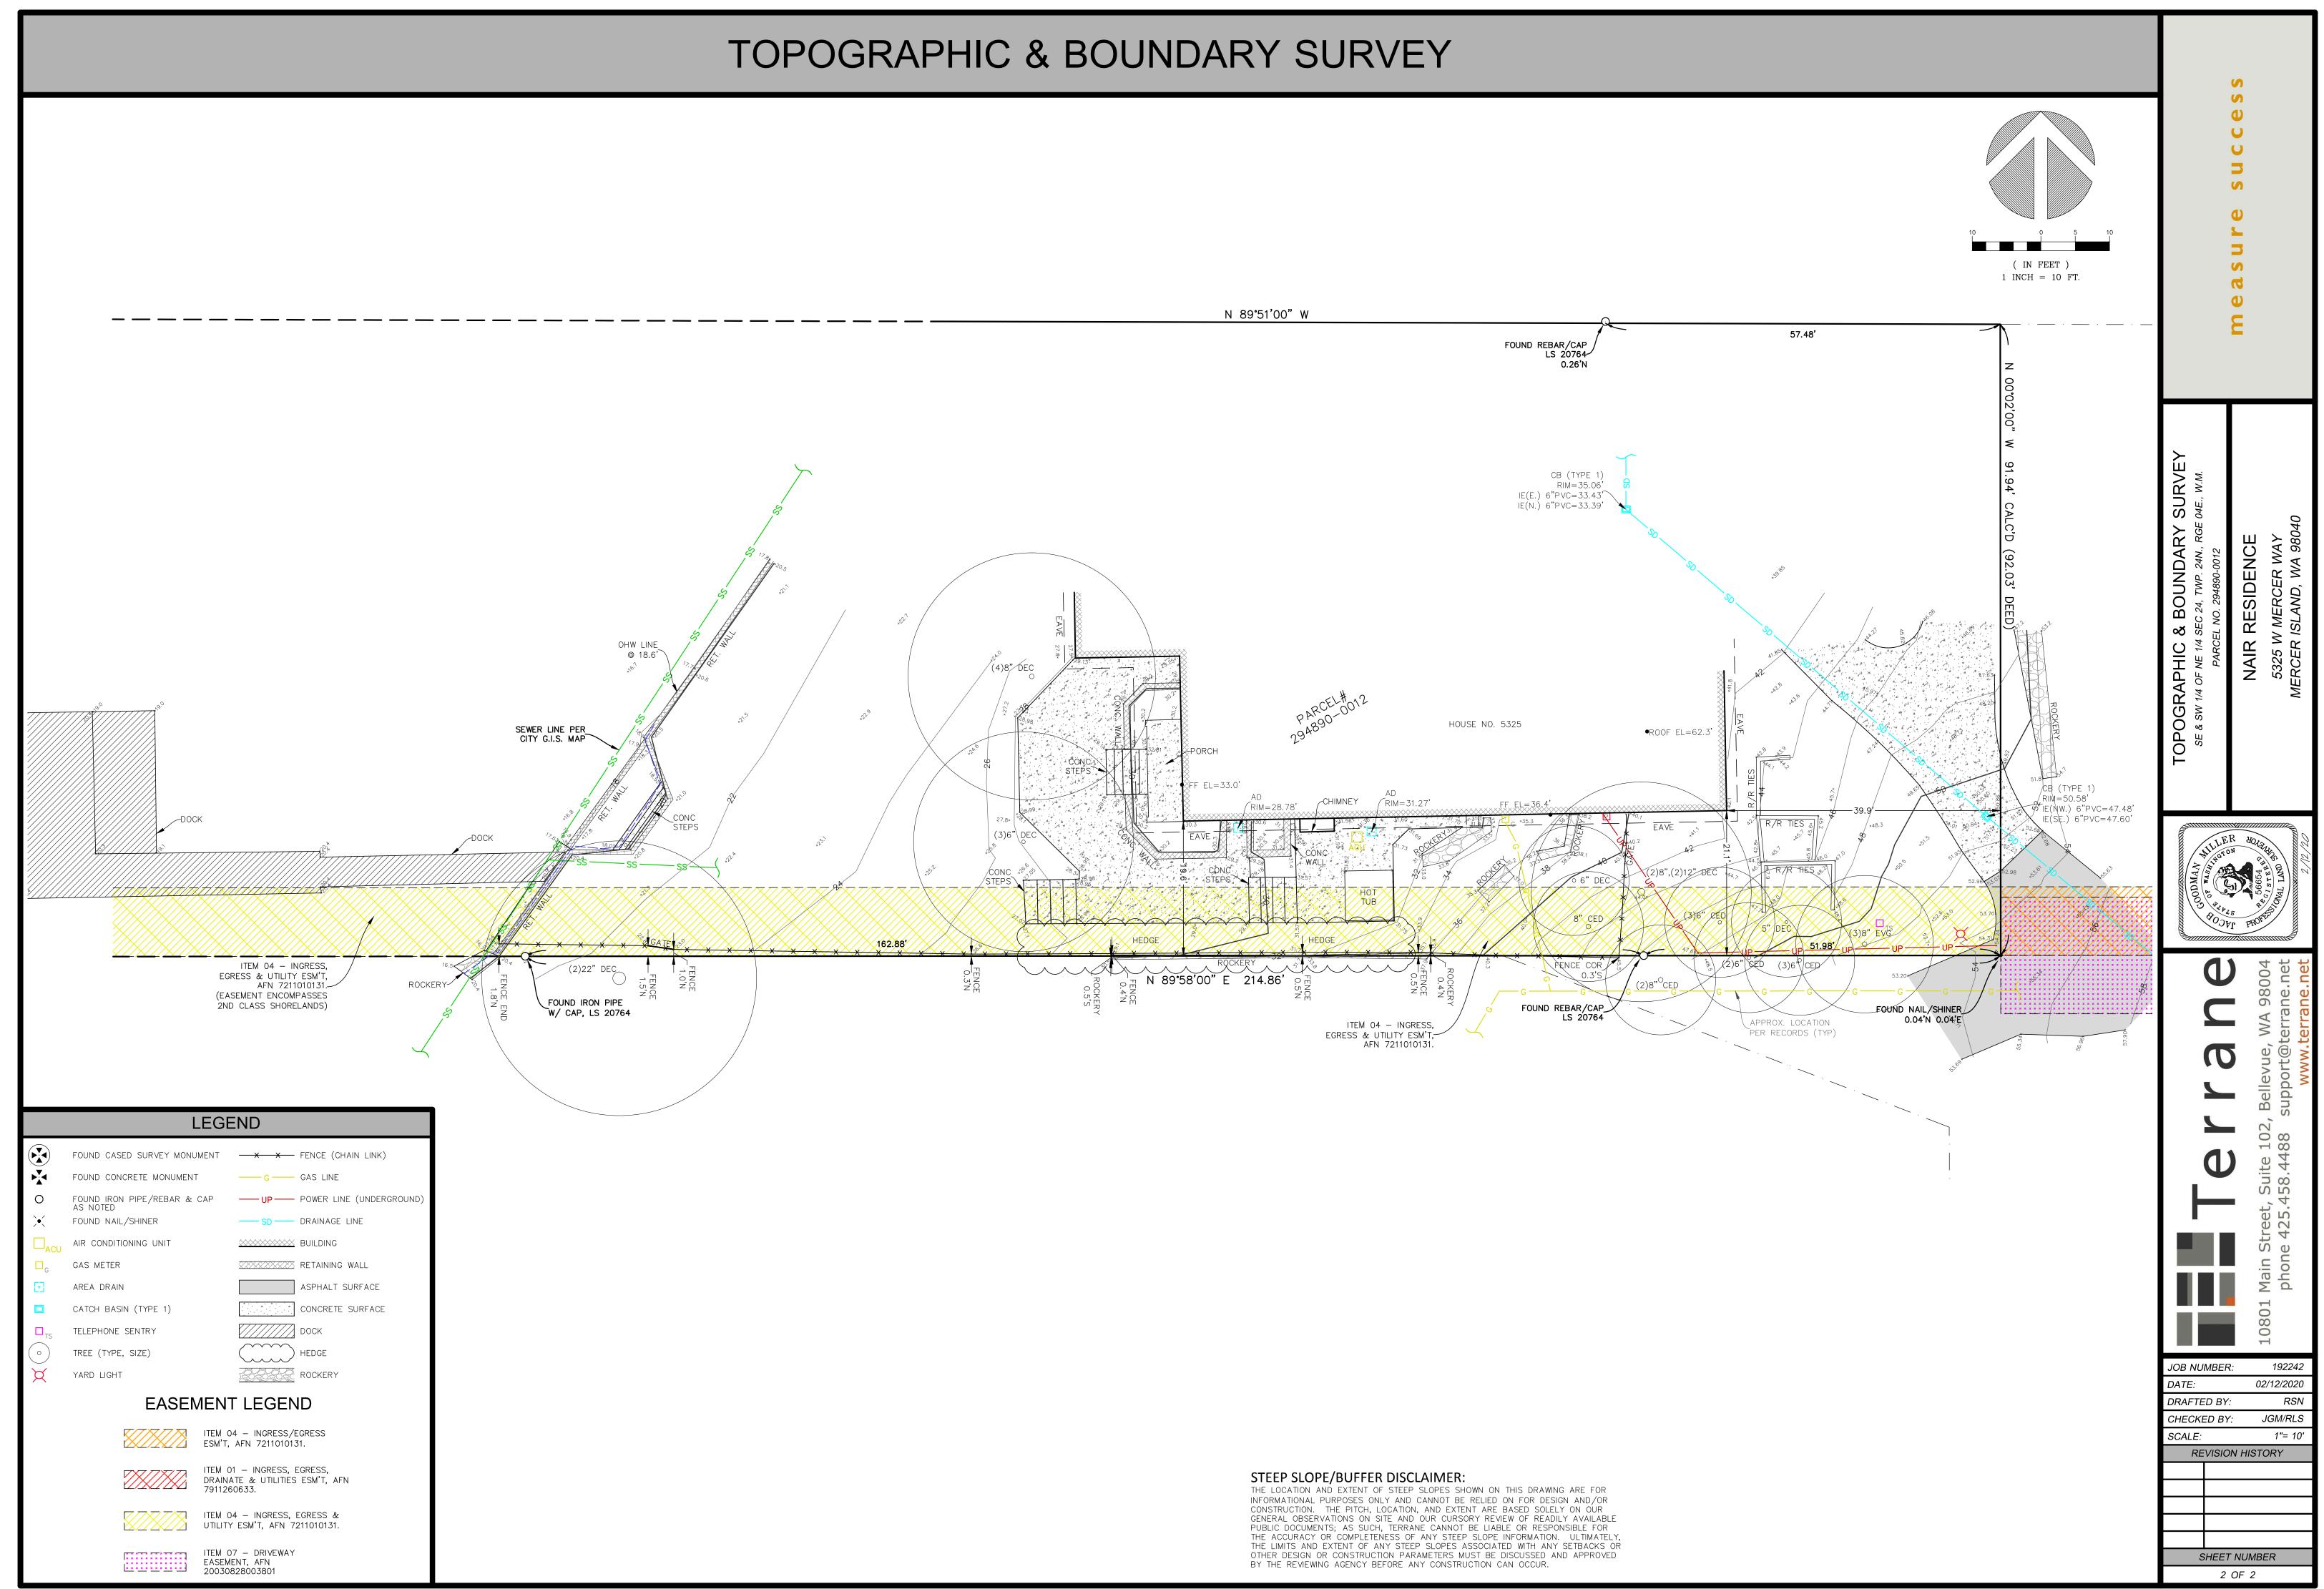

SHEET NO.

NOTE: SEE SHEET S2 FOR FOOTING SCHEDULE A1

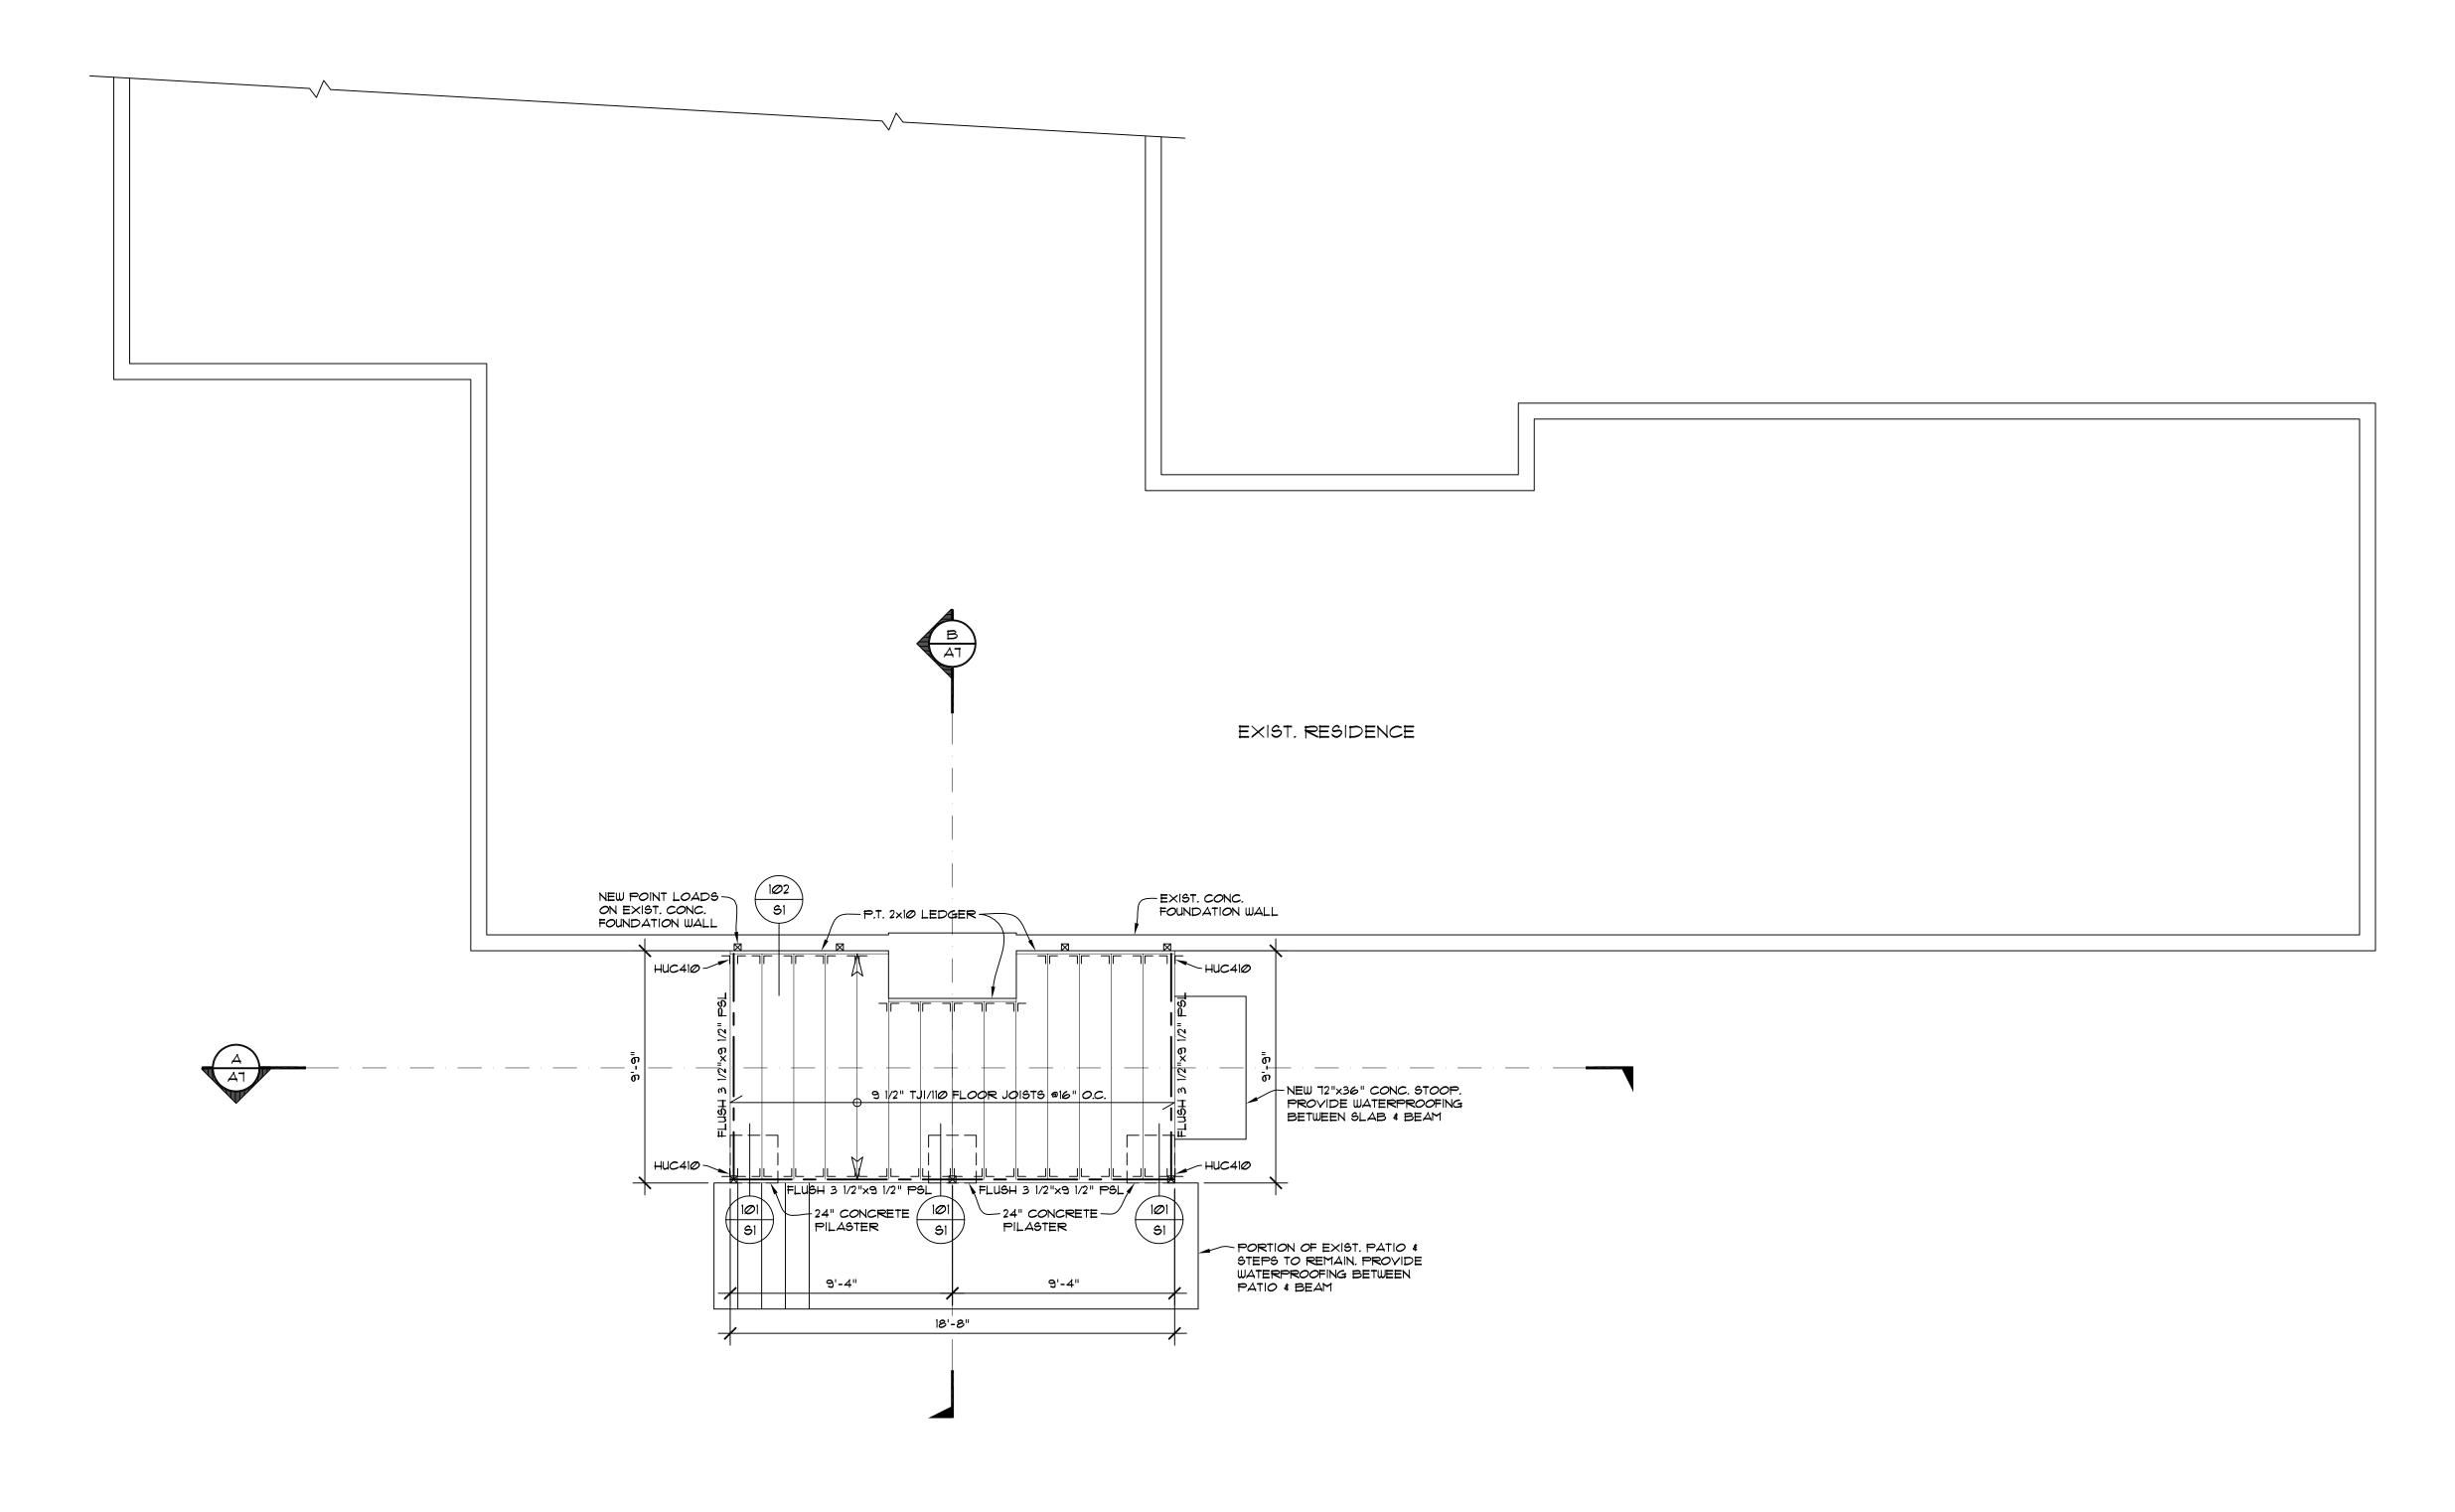

NORTH

FOUNDATION & MAIN FLOOR FRAMING PLAN SCALE: 1/4" = 1' - 0"



NAIR-WENDEL
OFFICE ADDITION
5325 WEST MERCER WAY
MERCER ISLAND, WA 98040


JOB NO: 19-022 DATE: 8/04/20 DRWN. BY:MM REVISED:

SHEET NO.

EXISTING WALLS TO BE REMOVED

NEW WALLS

A2

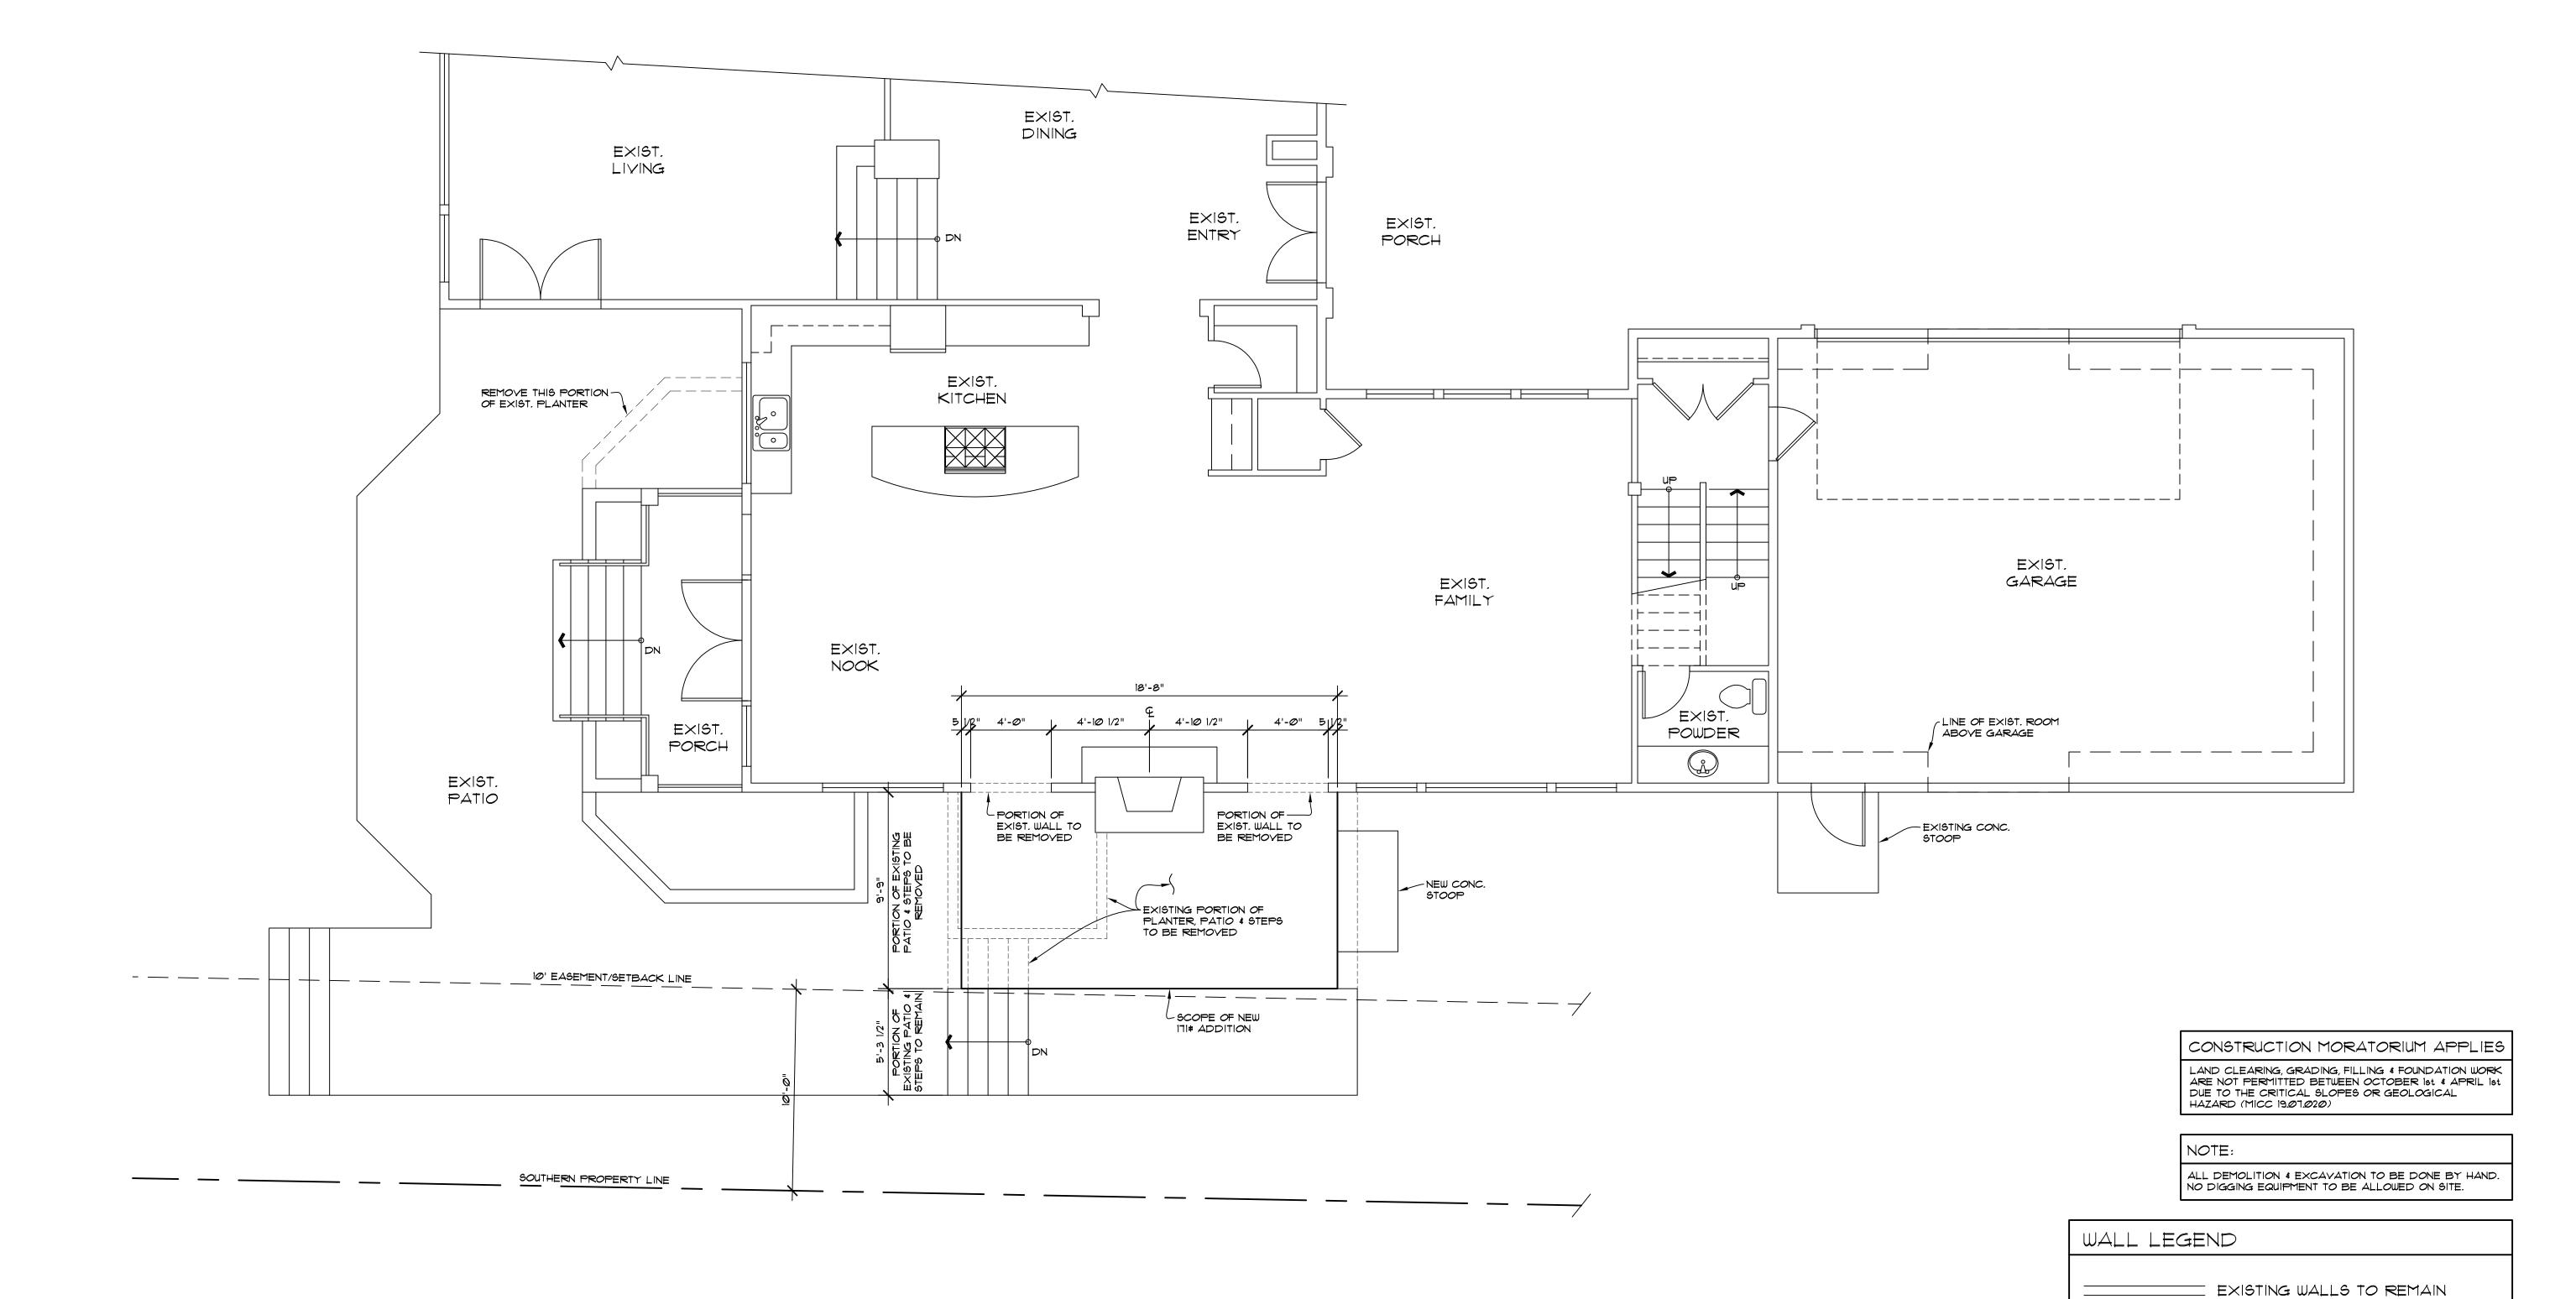

MAIN FLOOR DEMOLITION PLAN

SCALE: 1/4" = 1' - Ø"

EXIST. LIVING

NEW OUTDOOR KITCHEN

PORCH

EXIST.

PLANTER

SEE SHEET AT FOR

WINDOW/DOOR SCHEDULE

SPECIFIC -EQUIPMENT

AT

10' EASEMENT/SETBACK LINE

SOUTHERN PROPERTY LINE

EXIST.

PATIO

SQUARE FOOTAGE S	UMMA	RY
EXIST, MAIN FLOOR EXIST, UPPER FLOOR	3,138 507	SQ. FT. SQ. FT.
EXIST. TOTAL HEATED NEW OFFICE ADDITION	3,645 171	SQ. FT. SQ. FT.
TOTAL HEATED	3,816	SQ. FT.
EXIST. GARAGE	690	SQ. FT.

EXIST. KITCHEN

ARCHED OPENING -

4'-Ø"

(ART NICHE)

EXIST. DINING

ELEVATION

A7

BARREL VAULT

-EXIST. MASONRY F.P.

OFFICE

ITI# ADDITION

FLAT CEILING

6030 HALF

ROUND ABY.

EXIST

ENTRY

WALL LEGEND
EXISTING WALLS TO REMAIN
IIIIIIIIIII EXISTING WALLS TO BE REMOVED
NEW WALLS

EXIST.

PORCH

EXIST.

DEMO'D AREA NOT SHOWN FOR CLARITY. SEE SHEET A2 FOR MAIN FLOOR DEMOLITION PLAN

-EXTERIOR ACCESS

-NEW 12"x36" CONC. STOOP.

BETWEEN SLAB & BEAM

PROVIDE WATERPROOFING

TO SIDE YARD

ARCHED OPENING

2/8x8/Ø

ABV. M3 | STORE DR. (SG)

- PROVIDE WATERPROOFING

BETWEEN EXIST. PATIO & NEW

(HIDDEN DOOR)

4'-0"

2/8×8/Ø (S.C. DR.||

16040 PIC.

GENERAL NOTES:

I. ALL FLOOR JOISTS PER PLAN. REFER TO MFG. LAYOUT FOR ALL FRAMING DETAILS AND BLOCKING. REVIEW MFG. LAYOUT PRIOR TO FRAMING. DOUBLE UNDER BEARING PARTITIONS. PROVIDE SOLID BLOCKING OVER BEARING

2. ALL PRE-MANUFACTURED TRUSSES TO BE IDENTIFIED BY MFG'S STAMP.

3. FACTORY BUILT FIREPLACE & CHIMNEY TO BE UL LABELED INSTALL PER MANUFACTURERS SPECS O/SIDE COMBUSTION AIR REQ'D (MIN 6 SQ IN) DUCTED TO F/BOX W/ OPERABLE O/SIDE DAMPER, TIGHTLY FITTING FLUE DAMPER, AND TIGHT FITTING GLASS OR METAL DOORS OR FLUE DRAFT INDUCTION FAN.

4. LIMIT SHOWER FLOW TO 2.5 GALLON/MIN.

5. H.W.T. TO BE LABELED PER ASHRAE STD. NO. 90A-80, AND MEET THE REQUIREMENTS. PER 1987 NATIONAL APPLIANCE ENERGY CONSERVATION

6. FURNACE AND H.W. TANK, PILOTS, BURNERS, HEATING ELEMENTS, AND SWITCHES TO BE A MIN. OF 18" ABOVE FINISHED FLOOR.

7. ALL SKYLITES TO COMPLY WITH I.R.C. SECTION 2409.1 \$ 2603.7

SHOWN, 6" IN FROM EXTERIOR WALLS, 3" IN FROM INTERIOR WALLS.

2. ALL EXHAUST DUCTS INSULATED (MIN. OF R-4)

COMPLY WITH I.B.C. SECTION 2406. 9. HEAT REGISTERS TO BE PER LEGEND, LOCATE APPROXIMATELY AS

8. ALL SIDELITES, SLIDING GLASS DOORS AND TUB/SHOWER ENCLOSURES TO

I/O. VENT DRYER, OVEN/RANGE & EXHAUST FANS TO O/SIDE. DRYER EXHAUST DUCTS SHALL NOT EXCEED A TOTAL COMB HORIZ, AND VERT, LENGTH OF 14'-0", INCL. 2 90d. ELBOWS. DEDUCT 2'-0" FOR EA. 90d. ELBOW EXCEEDING

11. ALL NAILING PER IRC TABLE R602.3(1) AND/OR IBC TABLE 2304.9.1, COLUMN, POST & BEAM CONNECTIONS TO COMPLY WITH I.B.C. SECTION 2316.

12. SOLID SHT'G REQ'D ON LOWER STORY OF 2 STORY BUILDING PER I.B.C. DRYWALL NAILED PER SHEAR NAILING SCHEDULES OR IBC 2018 EDITION. 13. TUB/SHOWER SURROUND WALLS TO HAVE WATER RESISTANT GYP BOARD AND A SMOOTH HARD SURFACE TO A MINIMUM HEIGHT OF 10" ABOVE DRAIN

14. PROVIDE SMOKE DETECTOR IN COMPLIANCE WITH I.B.C. AND I.B.C. STD. *43.6. ALL SMOKE DETECTORS W/BAT BACKUP. SMOKE DETECTORS WILL SOUND AN AUDIBLE ALARM IN ALL SLEEPING ROOMS.

15. DWELLING TO COMPLY W/ 2018 IECC.

SHOWER, FIREPLACE, ETC.

16. SEAL, CAULK, GASKET, OR WEATHERSTRIP TO LIMIT AIR LEAKAGE: AT EXTERIOR JOINTS AROUND WINDOW AND DOOR FRAMES, OPENINGS BETWEEN WALL AND ROOF AND WALL PANELS, OPENINGS AT UTILITY PENETRATIONS THROUGH WALLS, FLOORS, AND ROOFS, ALL OTHER OPENINGS IN BUILDING ENVELOPE.

17. ALL EXTERIOR DOORS OR ACCESS HATCHES TO ENCLOSED UNHEATED AREAS MUST BE WEATHERSTRIPPED.

18. MINIMUM SOIL BEARING PRESSURE = 2000 PSF OR PER STRUCTURAL ENGINEERING..


19. FOOTINGS TO BE PLACED ON FIRM, UNDISTURBED NATIVE SOIL.

20. DWELLING TO COMPLY WITH 2018 INTERNATIONAL BUILDING CODE (I.B.C.) 21. FIRE STOPS SHALL BE PROVIDED TO CUT OFF ALL CONCL'D DRAFT OPENINGS FROM VERT. TO HORIZ. SPACES, INCLUDING THE STAIR, TUB,

S

ie

matthew mawer

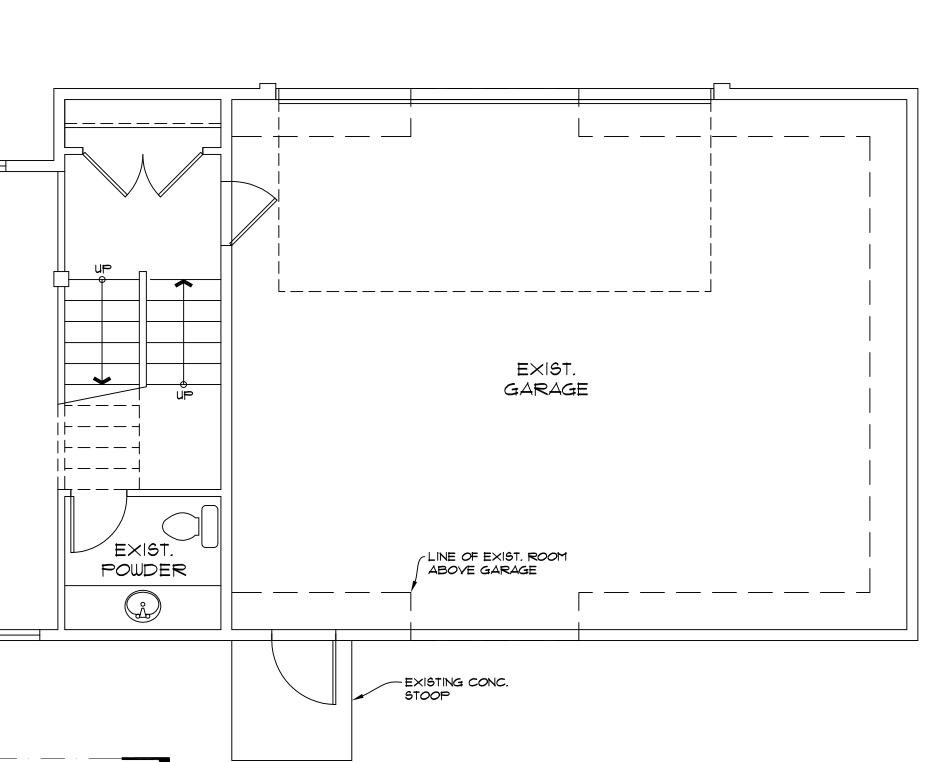

ALL WINDOW & DOOR HEADERS TO BE INSULATED W/ A MINIMUM OF R-10 INSULATION.

PER PERSCRIPTIVE REQUIREMENTS 2015 W.S.E.C. CLIMATE ZONE 4C

MAX. GLAZING U-FACTOR: VERT. U=.30, OVERHEAD U=.50 MAX. DOOR U-FACTOR: U=.20 INSULATION @ CONDITIONED ARES: TRUSSED CEILING: R-49

VAULTED & SINGLE RAFTER CEILING: R-38 (R402.2.2) ABOVE GRADE WALLS: R-21 BELOW GRADE WALLS: R-21 FLOOR OVER VENTED CRAWL SPACE: R-30 SLAB ON GRADE: R-10 @ PERIMETER

TIE INTO EXISTING FIRE SPRINKLER SYSTEM & ADD FIRE SPRINKLER(S) TO NEW ADDITION PER CITY OF MERCER ISLAND REQUIREMENTS.

SD

INDICATES HARD WIRED SMOKE DETECTOR WITH BATTERY BACKUP

ALL WINDOWS TO HAVE INDIVIDUAL OUTDOOR AIR INLET PORTS PER IMC 401.2 \$ 402.1

THE BUILDING THERMAL ENVELOPE SHALL BE CONSTRUCTED TO LIMIT AIR LEAKAGE. THE RESULTS OF THE TEST SHALL BE BY THE PARTY CONDUCTING THE TEST AND PROVIDED TO THE CODE OFFICIAL (R402.4.1.2).

AT LEAST ONE THERMOSTAT PER DWELLING UNIT SHALL BE CAPABLE OF CONTROLLING THE HEATING AND COOLING SYSTEM ON A DAILY SCHEDULE. DUCTS, AIR HANDLERS, AND FILTER BOXES SHALL BE SEALED. A MINIMUM OF 15% OF THE LAMPS IN PERMANENTLY INSTALLED LIGHTING FIXTURES

R317.1.3 GEOGRAPHICAL AREAS. APPROVED NATURALLY DURABLE OR PRESSURE-PRESERVATIVE-TREATED WOOD SHALL BE USED FOR THOSE PORTIONS OF WOOD MEMBERS THAT FORM THE STRUCTURAL SUPPORTS OF BUILDINGS, BALCONIES, PORCHES OR SIMILAR PERMANENT BUILDING APPURTENANCES WHEN THOSE MEMBERS ARE EXPOSED TO THE WEATHER WITHOUT ADEQUATE PROTECTION FROM A ROOF, EAVE, OVERHANG OR OTHER COVERING THAT WOULD PREVENT MOISTURE OR WATER ACCUMULATION ON THE SURFACE OR AT JOINTS BETWEEN MEMBERS. DEPENDING ON LOCAL EXPERIENCE, SUCH MEMBERS MAY INCLUDE:

1. HORIZONTAL MEMBERS SUCH AS GIRDERS, JOISTS AND DECKING.

2. VERTICAL MEMBERS SUCH AS POSTS, POLES AND COLUMNS.

3. BOTH HORIZONTAL AND VERTICAL MEMBERS.

R303.7 STAIRWAY ILLUMINATION.

SHALL BE HIGH-EFFICACY LAMPS.

ALL INTERIOR AND EXTERIOR STAIRWAYS SHALL BE PROVIDED WITH A MEANS TO ILLUMINATE THE STAIRS, INCLUDING THE LANDINGS AND TREADS. INTERIOR STAIRWAYS SHALL BE PROVIDED WITH AN ARTIFICIAL LIGHT SOURCE LOCATED IN THE IMMEDIATE VICINITY OF EACH LANDING OF THE STAIRWAY. FOR INTERIOR STAIRS THE ARTIFICIAL LIGHT SOURCES SHALL BE CAPABLE OF ILLUMINATING TREADS AND LANDINGS TO LEVELS NOT LESS THAN I FOOT-CANDLE (II LUX) MEASURED AT THE CENTER OF TREADS AND LANDINGS. EXTERIOR STAIRWAYS SHALL BE PROVIDED WITH AN ARTIFICIAL LIGHT SOURCE LOCATED IN THE IMMEDIATE VICINITY OF THE TOP LANDING OF THE STAIRWAY. EXTERIOR STAIRWAYS PROVIDING ACCESS TO A BASEMENT FROM THE OUTSIDE GRADE LEVEL SHALL BE PROVIDED WITH AN ARTIFICIAL LIGHT SOURCE LOCATED IN THE IMMEDIATE VICINITY OF THE BOTTOM LANDING OF THE STAIRWAY.

JOB NO: 19-022 DATE: 8/04/20 DRWN. BY: MM REVISED:

NAIR-WENDEL

OFFICE A 5325 WEST N MERCER ISLA

SHEET NO.



EXIST.

WALL OF NEW ADDITION -2-3/8" INSIDE SETBACK

(VERIFY ON SITE)

MAIN FLOOR PLAN SCALE: 1/4" = 1' - 0"

-EXIST. STEPS & PATIO AREA

TO BE RECONFIGURED

ROOF VENTILATION CALCULATIONS

TOTAL VENTILATION REQUIRED $\frac{171\#}{300}$ = 0.51 S.F. NET FREE

(PROVIDE EAVE VENT BLOCKING @ EVERY BAY)
MIN. 50% BY VENTILATION ABOVE EAVE = 0.51 x 0.5 = 0.29 S.F. (2) AF-50 ROOF JACK YIELD .01 S.F. (.35 S.F. NET FREE EACH)


-SHALL CARRY MANUFACTURERS STAMP
-SHALL BE INSTALLED & BRACED TO MANUFACTURERS SPECIFICATIONS
-WILL NOT BE FIELD ALTERED WITHOUT PRIOR BUILDING DEPARTMENT

EAVE VENTILATION = 5 LF. x 3.3 SQ. IN./L.F. = Ø.II S.F.

TOTAL VENTILATION PROVIDED: EAVE VENTILATION = Ø.11 S.F. ABOVE EAVE VENTILATION = Ø.7 S.F.

ALL TRUSSES:

TOTAL VENTILATION REQUIRED = 0.81 S.F. TOTAL VENTILATION PROVIDED = 0.57 S.F.

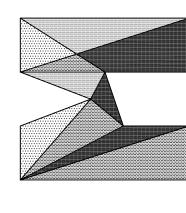


lifestyle


NAIR-WENDEL
OFFICE ADDITION
5325 WEST MERCER WAY
MERCER ISLAND, WA 98040

JOB NO: 19-022 DATE: 8/04/20 DRWN. BY:MM REVISED:

SHEET NO.

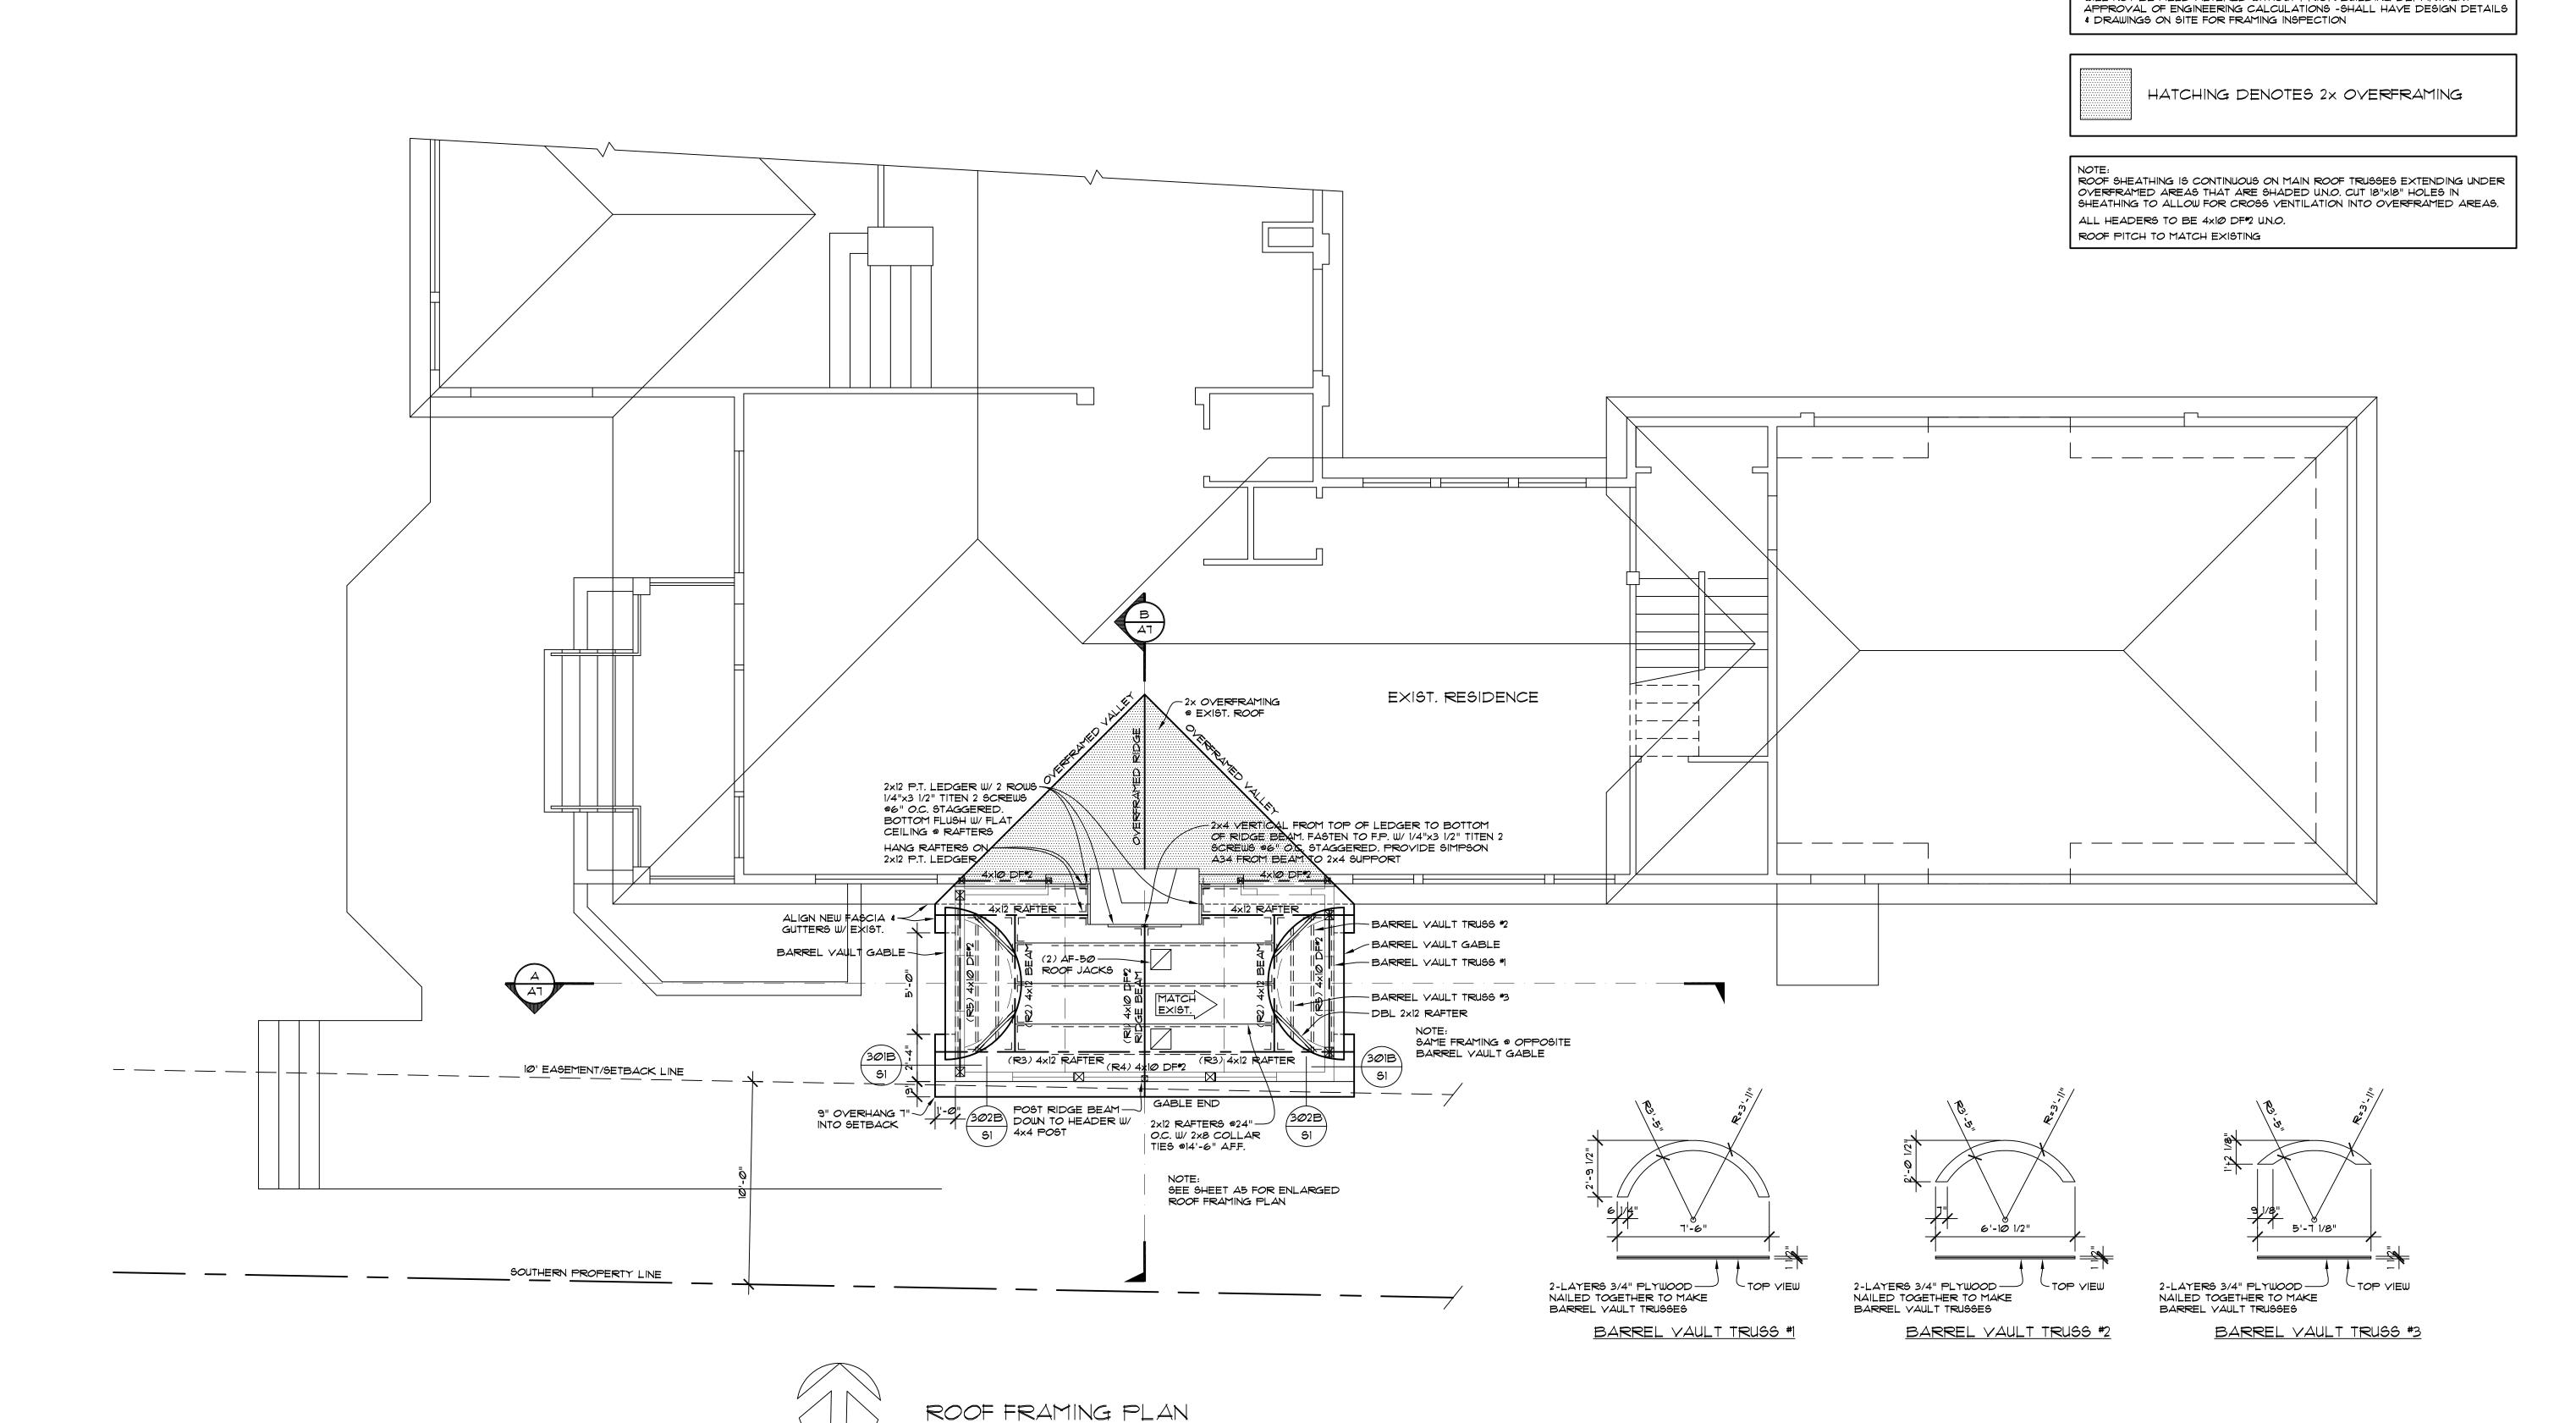

SCALE: 1/4" = 1' - 0"

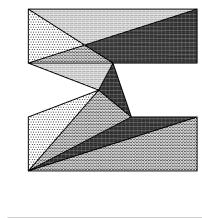



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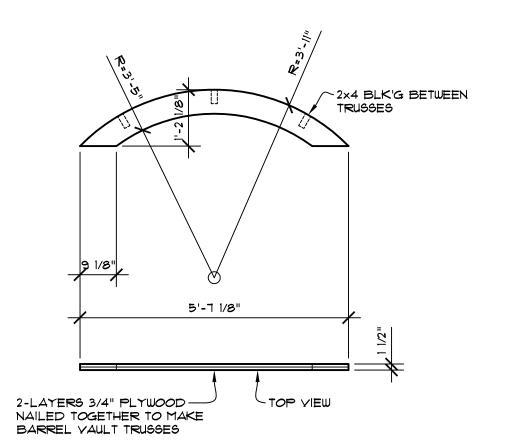
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MERCER ISLAND, WA 98040

JOB NO: 19-022 DATE: 8/04/20 DRWN. BY:MM REVISED:

SHEET NO.




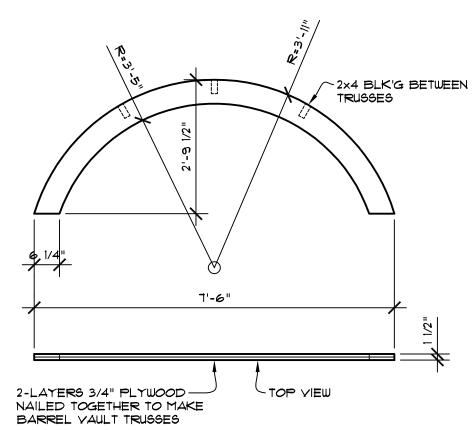

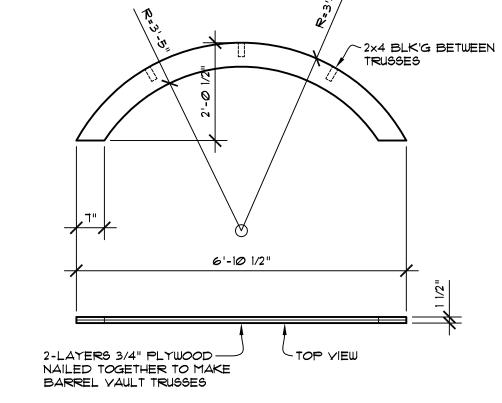

BARREL VAULT TRUSS #1


BARREL VAULT TRUSS #2 BARREL VAULT TRUSS #3

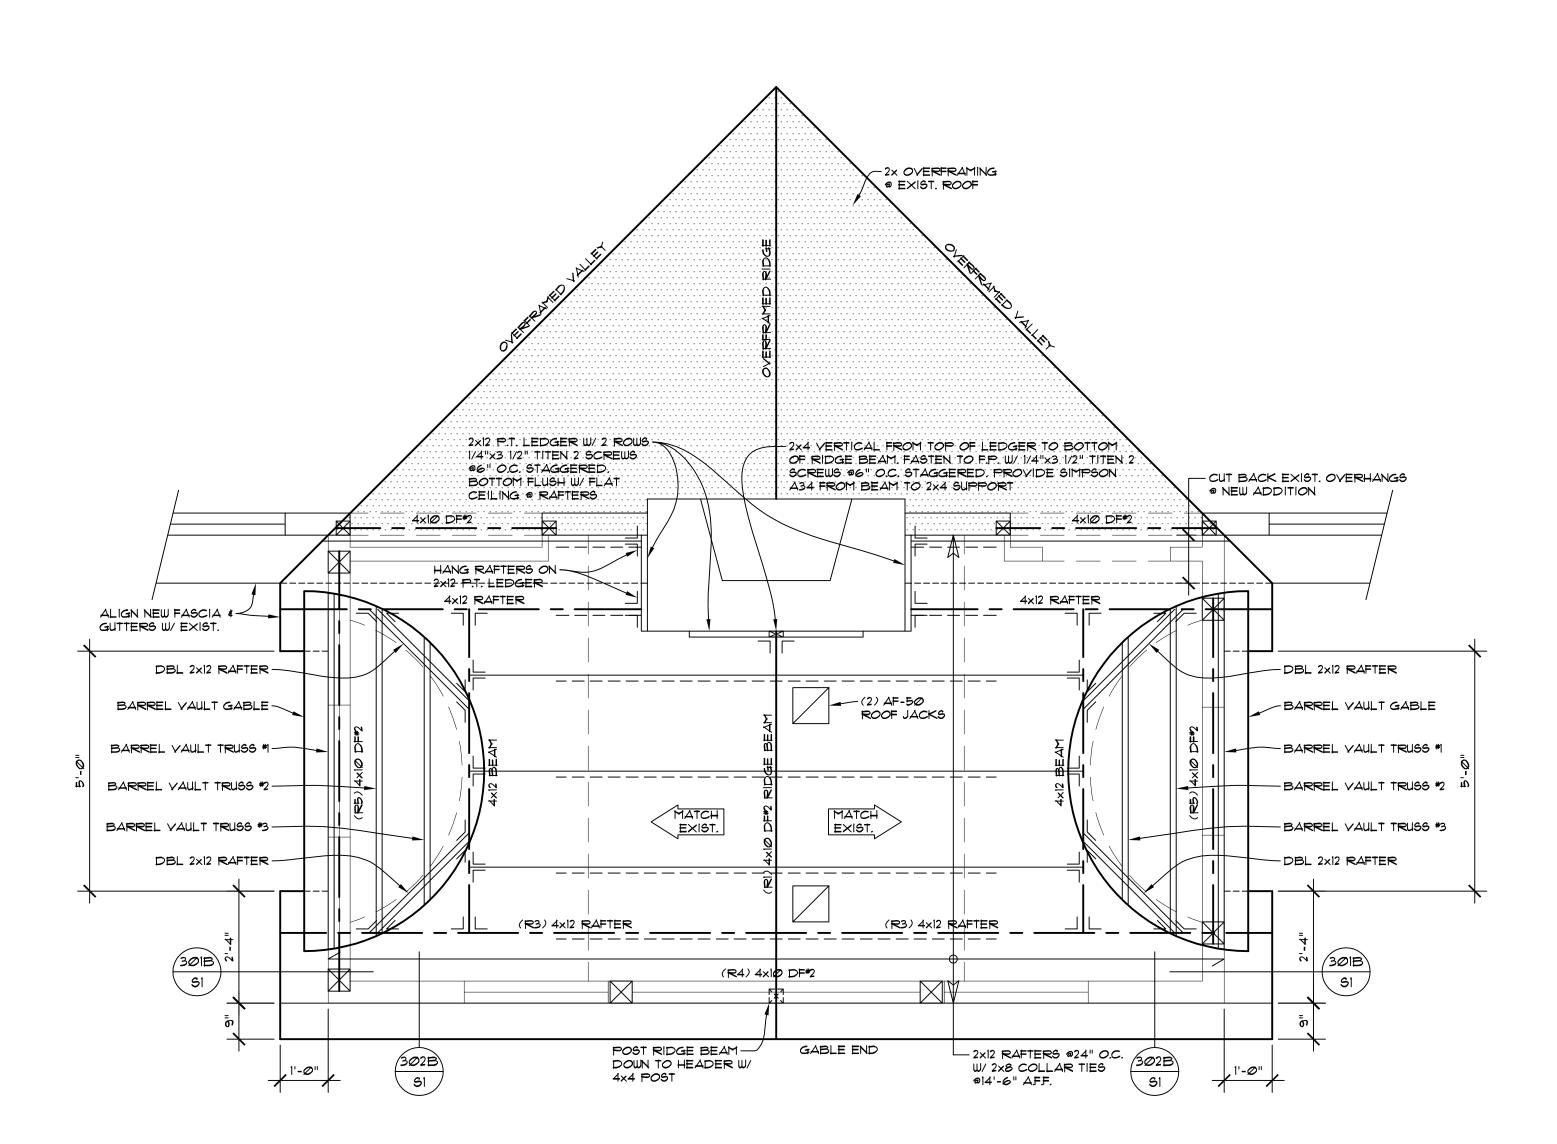



ENLARGED ROOF FRAMING PLAN

SCALE: 1/2" = 1' - Ø"

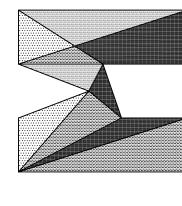


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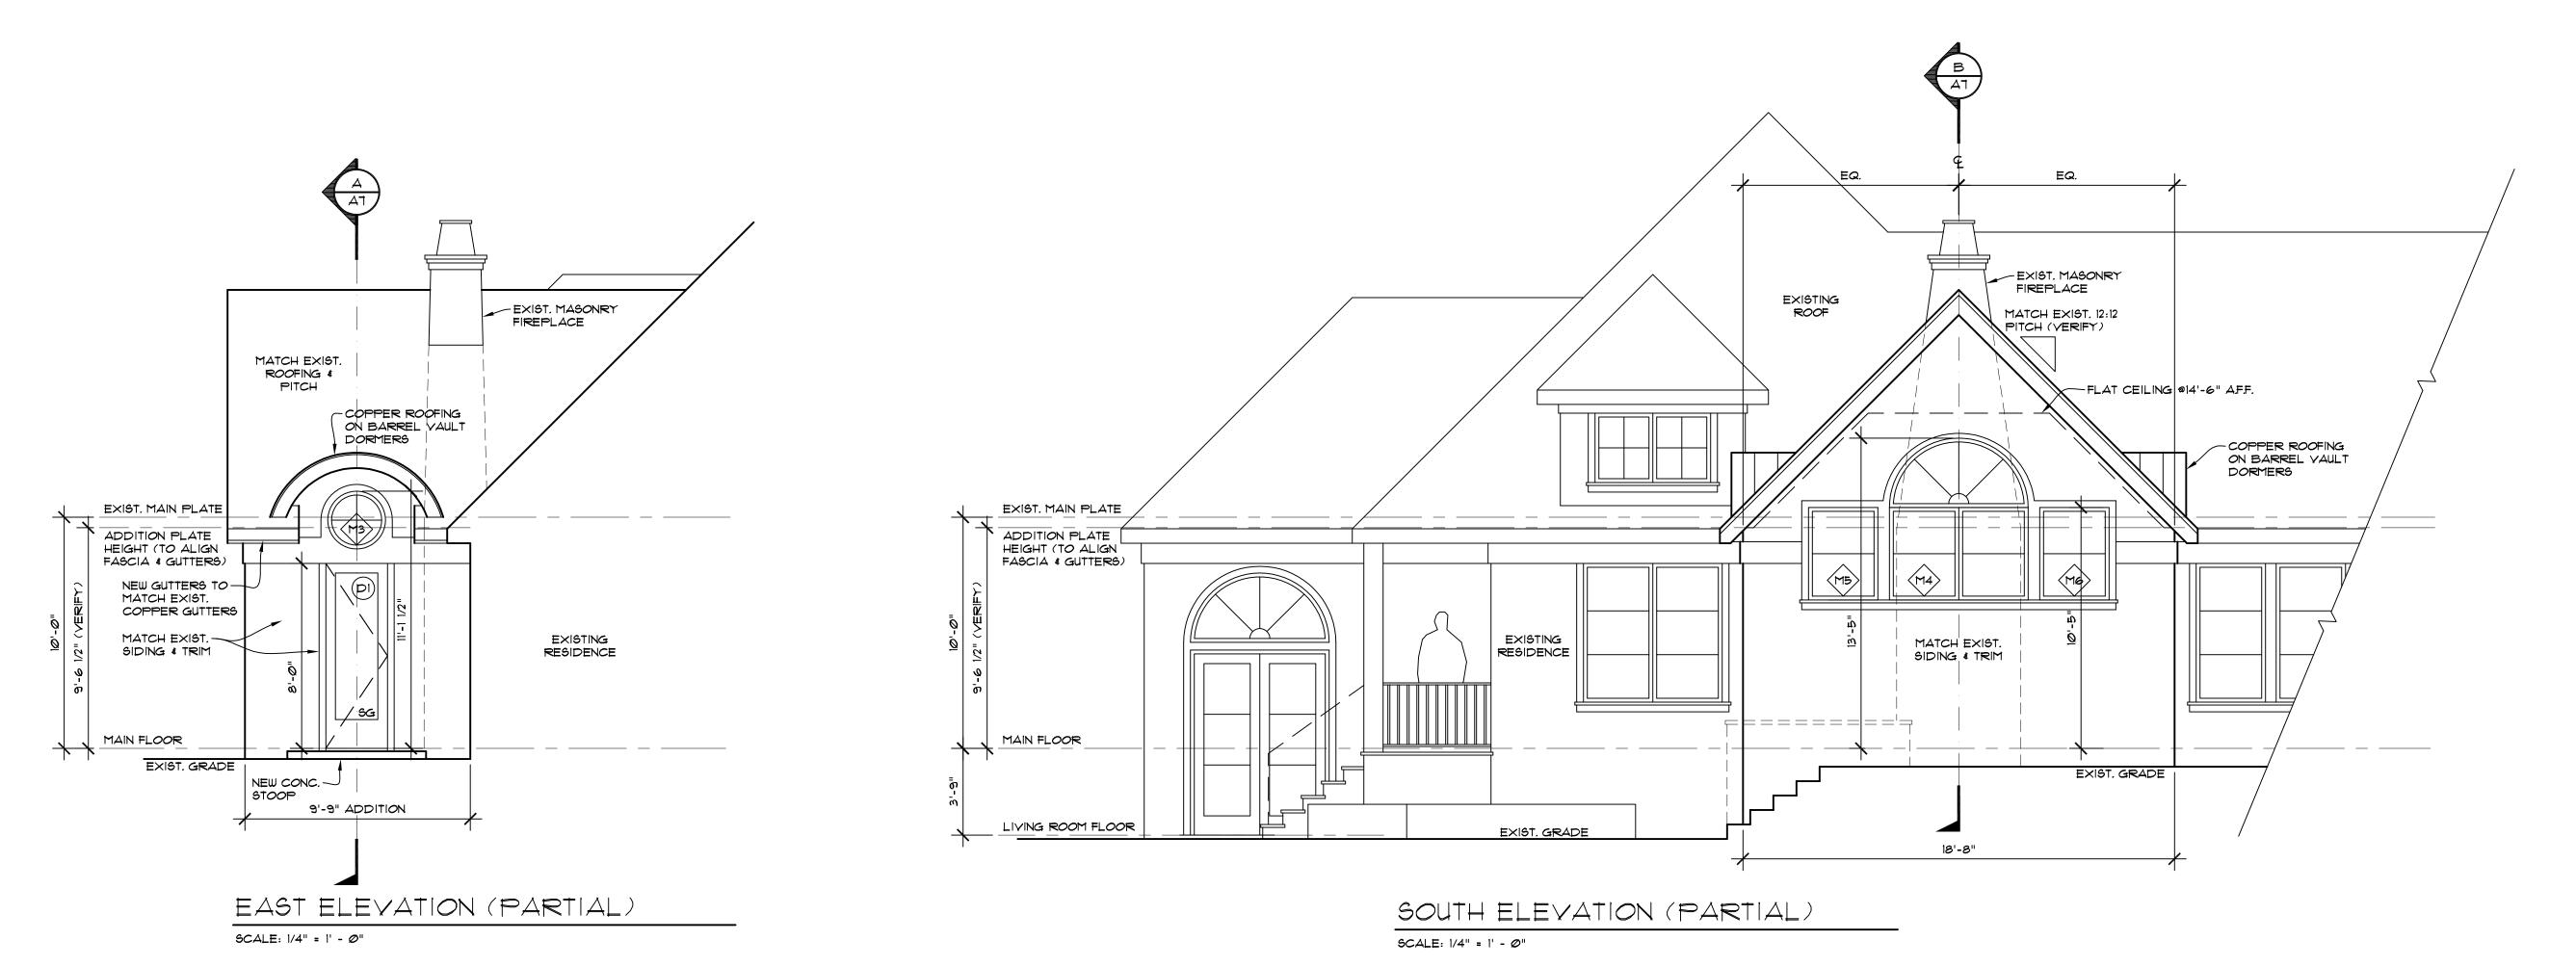
NAIR-WENDEL
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5325 WEST MERCER WAY
MERCER ISLAND, WA 98040


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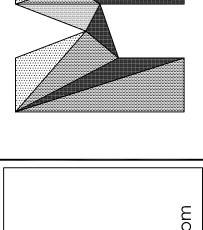
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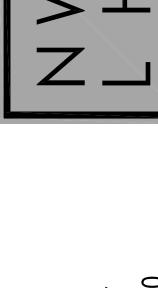








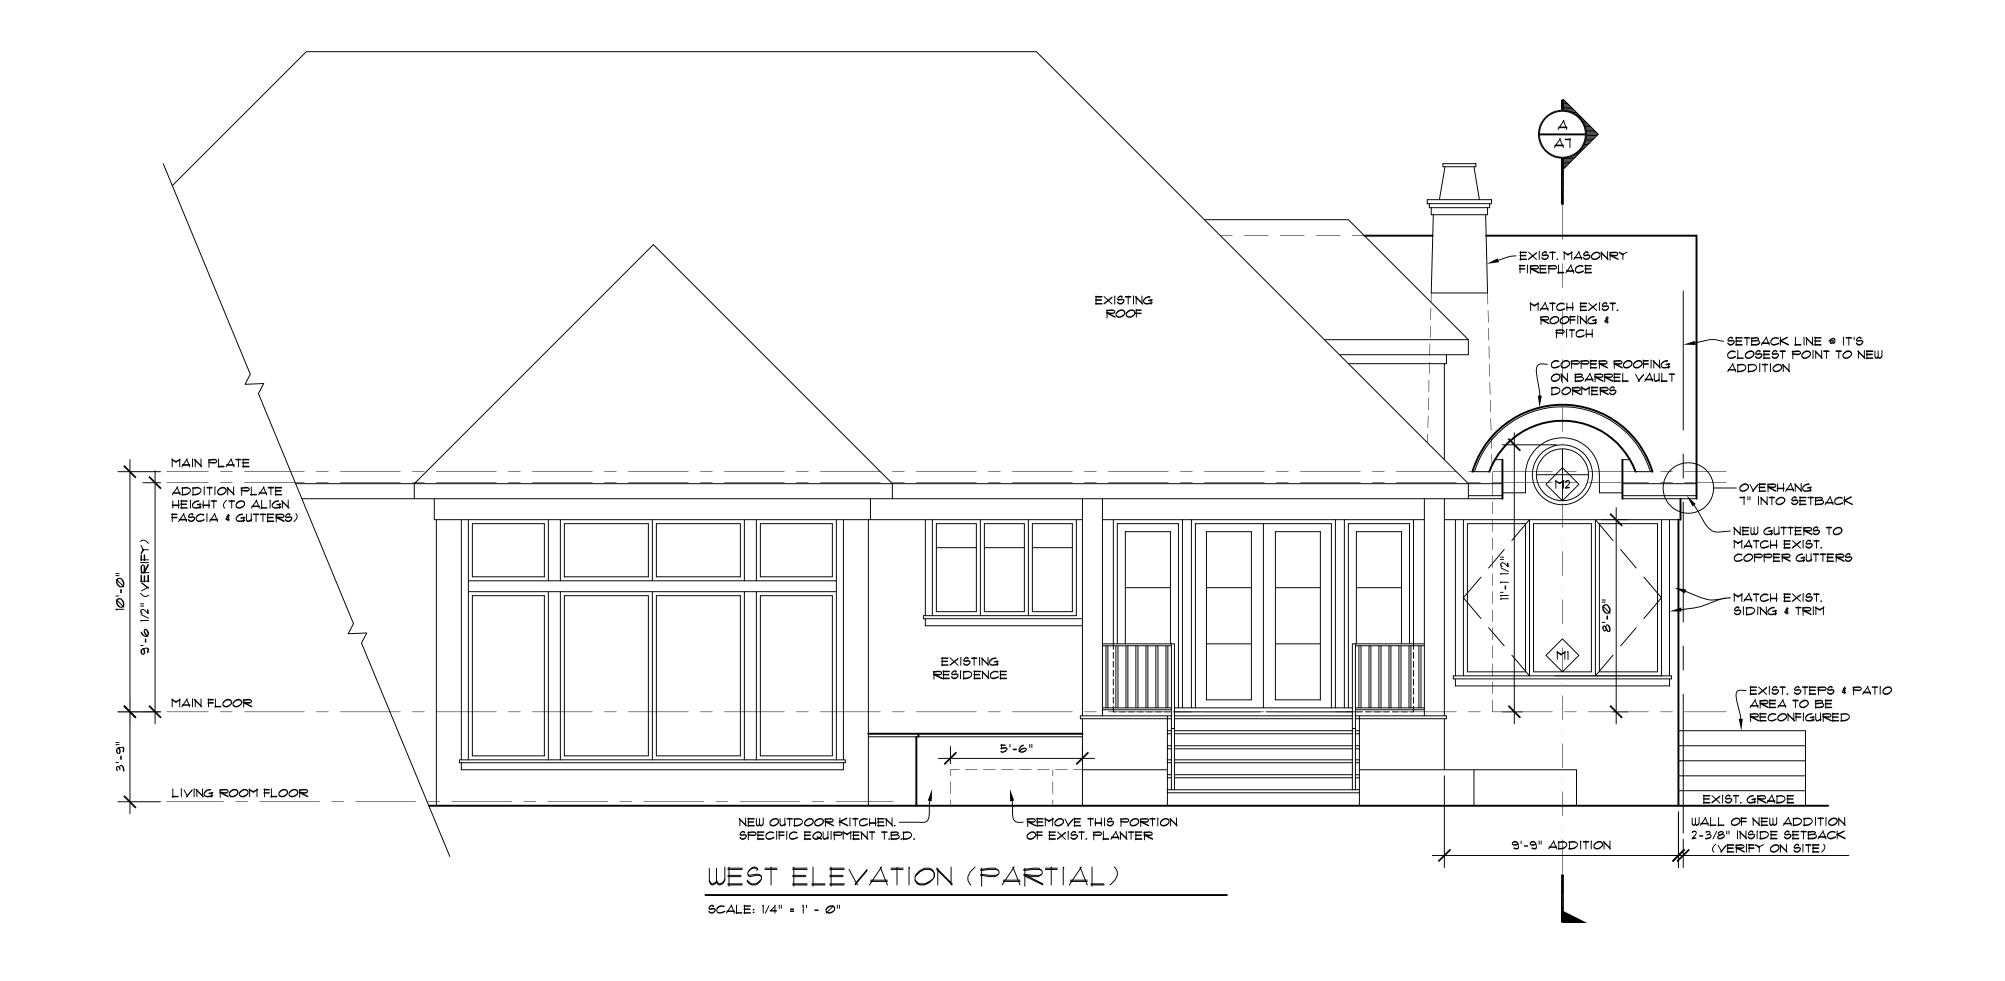


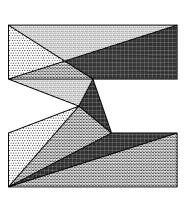



NAIR-WENDEL
OFFICE ADDITION
5325 WEST MERCER WAY
MERCER ISLAND, WA 98040

JOB NO: 19-022 8/04/20 DRWN. BY:MM REVISED:

SHEET NO.

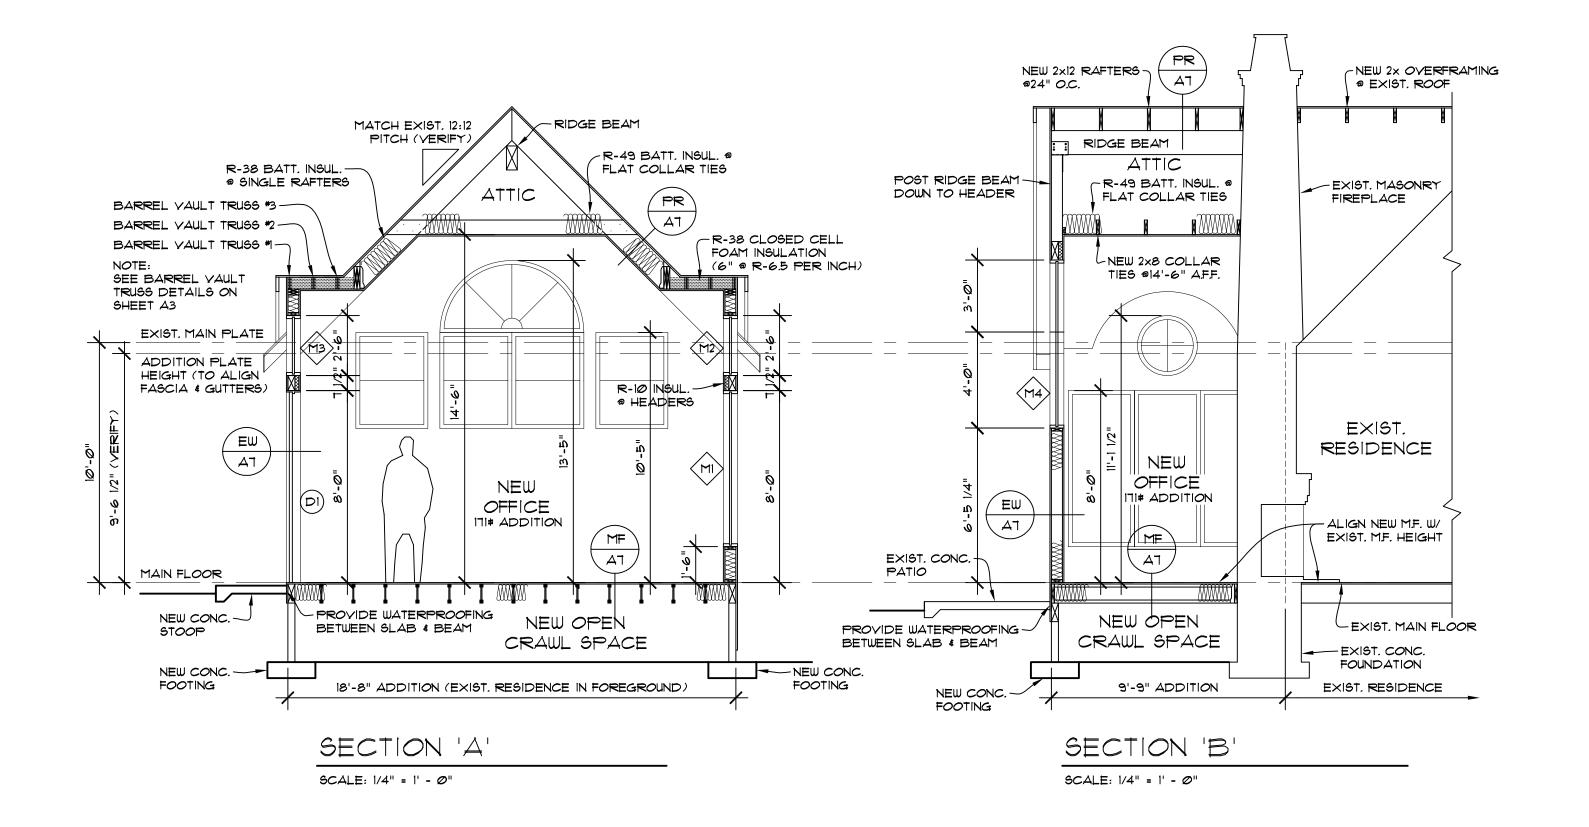

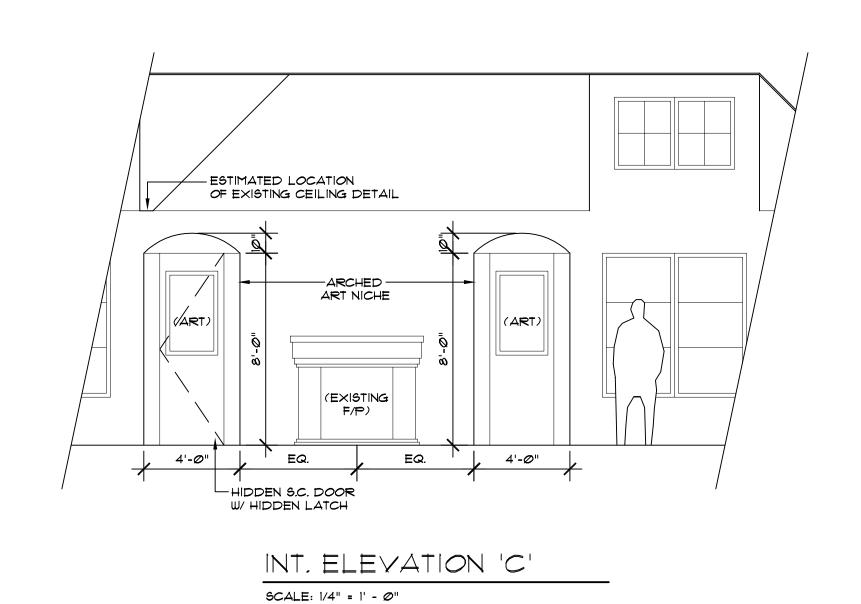

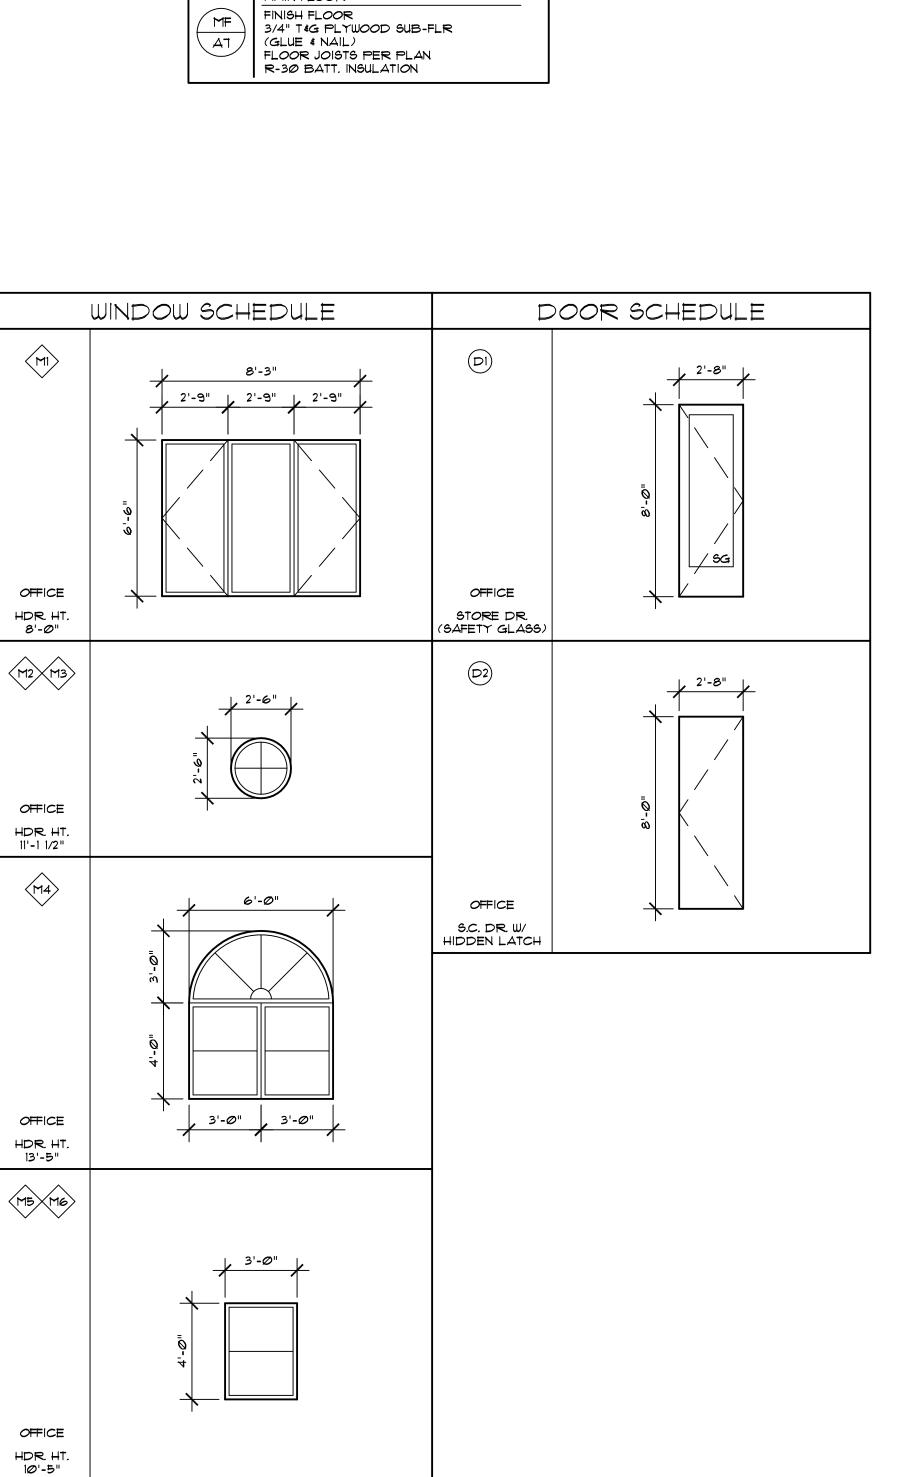

PITCHED ROOF

EXTERIOR WALL

MAIN FLOOR

PR

EW

MF

ΔΤ

PITCHED ROOF

MATCH EXIST. ROOFING:
30* BUILDING: PAPER
OSB ROOF SHEATHING:
2x RAFTERS PER PLAN
R-38 INSULATION @ SINGLE RAFTER ROOF
R-49 INSULATION @ FLAT COLLAR TIES
4 MIL. U.Y. POLY.
5/8" GWB


1/2" G.W.B.

4 MIL UV RES. POLY
2x6 STUDS @ 16" O.C.
R-21 BATT INSULATION
SHEATHING PER SHEAR WALL SCHED.
BUILDING PAPER
SIDING PER ELEVATIONS

SHEAR WALL SCHEDULE

MARK	SHEATHING	FASTENER SPACING	BOTTOM PLATE NAILING OR	FRAMING ANCHORS	ALLOWABLE	NOTES
, viral	(NOTE 5)	(COMMON OR	ANCHOR BOLTS	(NOTES 7 & 8)	SHEAR	
	(110.120)	GALVANIZED BOX)				
1A	7/16" MIN. APA RATED SHEATHING OR		16d @ 8" OC	RBC @ 32"OC		1, 2, 3,
	APA RATED SIDING 303	8d @ 6"OC	OR	LTP4@ 48"OC	130 PLF	11
	ONE SIDE		½" A.B. @ 5'-6"OC	A35 @ 48"OC		
1	7/16" MIN. APA RATED SHEATHING OR		16d @ 6" OC OR	RBC @ 18"OC		1, 2, 3,
-	APA RATED SIDING 303	8d @ 6"OC	½" A.B. @ 3'-2"OC OR	LTP4@ 30"OC	242 PLF	11
	ONE SIDE		5/8" A.B. @ 5'-0" OC	A35 @ 30"OC		
2	7/16" MIN. APA RATED SHEATHING OR		16d @ 4" OC OR	RBC @ 12"OC		1, 2, 3,
-	APA RATED SIDING 303	8d @ 4"OC	½" A.B. @ 2'-2"OC OR	LTP4@ 18"OC	353 PLF	11
	ONE SIDE		5/8" A.B. @ 3'-4" OC	A35 @ 18"OC		
3	7/16" MIN. APA RATED SHEATHING OR		1/4" X 5" LAG SCREW @ 8"OC OR	RBC @ 10"OC		1, 2, 3,
•	APA RATED SIDING 303	8d @ 3"OC	½" A.B. @ 1'-8"OC OR	LTP4@ 15"OC	456 PLF	4, 9, 10
	ONE SIDE		5/8" A.B. @ 2'-8" OC	A35 @ 15"OC		11
4	7/16" MIN. APA RATED SHEATHING OR		1/4" X 5" LAG SCREW @ 6"OC OR	RBC @ 8"OC		1, 2, 3,
•	APA RATED SIDING 303	10d @ 3"OC	½" A.B. @ 1'-4"OC OR	LTP4@ 12"OC	558 PLF	4, 9, 10
	ONE SIDE		5/8" A.B. @ 2'-0" OC	A35 @ 12"OC		11
5	7/16" MIN. APA RATED SHEATHING OR		1/4" X 5" LAG SCREW @ 5"OC OR	RBC @ 6"OC		1, 2, 3
_	APA RATED SIDING 303	10d @ 2"OC	½" A.B. @ 1'-0"OC OR	LTP4 @ 10"OC	716 PLF	4, 9, 10
	ONE SIDE		5/8" A.B. @ 1'-8"OC	A35 @ 10"OC		11
6	19/32" MIN. APA RATED SHEATHING		1/4" X 5" LAG SCREW @ 2"OC OR			1, 2, 3,
-	BOTH SIDES	10d @ 2"OC	3/4" A.B. @ 1'-0" OC	LTP4@ 6"OC	1618 PLF	4, 6, 9
				A35 @ 6"OC		10, 11

- 1. ALL FASTENERS SHALL MEET THE FOLLOWING CRITERIA: 8d COMMON = 0.131" DIAMETER X 2 ½", 8d GALVANIZED BOX = 0.113 DIAMETER X 2 ½" 10d COMMON = 0.148" DIAMETER X 3", 10d GALVANIZED BOX = 0.128" DIAMETER X 3", 16d COMMON = 0.162" X 3 ½".
- PANEL EDGES SHALL BE BACKED WITH 2" NOMINAL OR WIDER FRAMING. SPACE FASTENERS @ 12"OC ON INTERMEDIATE SUPPORTS.
- 3. PROVIDE ALL ANCHOR BOLTS WITH 3" X 3" X ¾" PLATE WASHERS. LOCATE WITHIN ½" OF SHEATHING.
- 4. AT GARAGE JAMBS, REFER TO LATERAL RESTRAINT PANEL DETAIL 401/S1.
- 5. PROVIDE 7/16" APA RATED SHEATHING (PLYWOOD OR OSB) OR APA RATED SIDING 303 OR INNER SEAL OSB RATED PANEL SIDING ON ALL EXTERIOR WALLS DESIGNATED AS SHEAR WALLS.
- 6. WHERE PANELS ARE APPLIED ON BOTH SIDES OF A WALL AND NAIL SPACING IS LESS THAN 6" OC ON EITHER SIDE, PANEL JOINTS SHALL BE OFFSET TO FALL ON DIFFERENT FRAMING MEMBERS OR FRAMING SHALL BE 3" NOMINAL OR THICKER AND NAILS ON EACH SIDE SHALL BE STAGGERED.
- 7. REFER TO TYPICAL SHEAR WALL DETAILS ON STRUCTURAL DETAIL SHEET FOR LOCATION OF FRAMING ANCHORS.
- 8. AT UPPER FLOOR INTERIOR SHEAR WALLS, REFER TO DETAIL 303/S2 OR 304/S2.
- 9. AT SHEAR WALL TYPES 3, 4, 5 AND 6, ALL FRAMING MEMBERS RECEIVING EDGE NAILING FROM ABUTTING PANELS SHALL NOT BE LESS THAN A SINGLE 3X MEMBER. FOR EXAMPLE, PROVIDE A 3X STUD AT VERTICAL JOINTS IN THE SHEATHING.
- 10. AT SHEAR WALL TYPES 3, 4, 5 AND 6, FOUNDATION SILL PLATES AND BOTTOM PLATES OF SHEAR WALLS, SHALL NOT BE LESS THAN A SINGLE 3X MEMBER. ALSO PROVIDE A 3X MINIMUM WIDTH MEMBER BELOW SHEAR WALL TO RECEIVE LAG SCREWS SUCH AS A 3X RIM JOIST, 3X JOIST OR BEAM OR BLOCKING BELOW SHEAR WALL.
- 11. FASTENERS AT PRESSURE PRESERVATIVE AND FIRE RETARDANT TREATED WOOD SHALL BE STAINLESS STEEL, G185 HDG, BATCH/POST HOT-DIP GALVANIZED OR MECHANICALLY GALVANIZED.

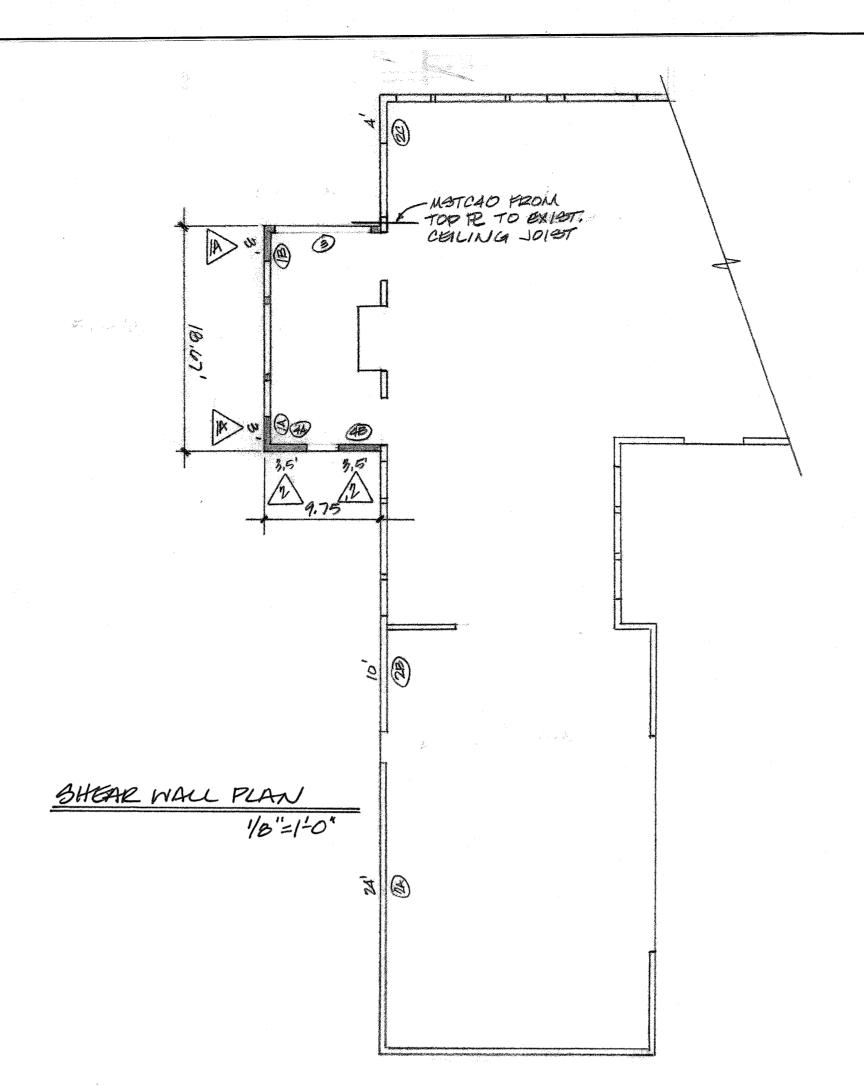

STRUCTURAL NOTES

CODES AND SPECIFICATIONS

- 1. INTERNATIONAL BUILDING CODE, 2015 EDITION, ASCE 7-10
- INTERNATIONAL RESIDENTIAL CODE, 2015 EDITION 3. SIMPSON STRONG TIE WOOD CONTRUCTION CONNECTORS 2015-2016
- 4. FASTENERS IN CONTACT WITH PRESSURE TREATED WOOD MUST BE STAINLESS STEEL, ZMAX(G185HDG PER ASTM A653), BATCH/POST HOT-DIP GALVANIZED (PER ASTM B695, CLASS 55 OR GREATER). UNCOATED AND PAINTED PRODUCTS SHOULD NOT BE USED WITH TREATED WOOD. WHEN USING STAINLESS STEEL HOT-DIP GALVANIZED CONNECTORS, THE CONNECTORS AND FASTENERS SHOULD BE MADE OF THE SAME MATERIAL.

DESIGN CRITERIA


- 1. WIND LOAD: INTERNATIONAL BUILDING CODE, 2015, ASCE 7-10, ALTERNATE ALL-HEIGHTS METHOD, ULTIMATE DESIGN WIND SPEED = 110 MPH, NOMINAL DESIGN WIND SPEED = 85 MPH, EXPOSURE B
- 2. SEISMIC: INTERNATIONAL BUILDING CODE, 2015, ASCE 7-10
- RISK CATEGORY II SEISMIC IMPORTANCE FACTOR, le=1.0 MAPPED SPECTRAL RESPONSE ACCELERATION PARAMETERS, Ss=1.5, S1=0.5
- DESIGN SPECTRAL RESPONSE ACCELERATION PARAMETERS, Sds=1.0g, Sd1=0.5g SEISMIC DESIGN CATEGORY D2
- BASIC SEISMIC FORCE-RESISTING SYSTEM: LIGHT FRAME WALLS WITH WOOD SHEAR WALLS DESIGN BASE SHEAR, V = F (Sds) (W) / R = 0.1846 (W)
- RESPONSE MODIFICATION COEFFICIENT, R=6.5 ANALYSIS PROCEDURE USED: SIMPLIFIED ALTERNATIVE STRUCTURAL DESIGN FOR SIMPLE BEARING WALL SYSTEMS
- DL = 15 PSF LL = 25 PSF (ROOF SNOW LOAD) ROOF LOAD:
- 4. FLOOR LOAD: DL = 10 PSF LL = 40 PSF
- DL = 10 PSF LL = 60 PSF DECK LOAD:
- ASSUMED 1500 PSF ALLOWABLE SOIL BEARING 6. SOILS:
 - ASSUMED 35 PCF ACTIVE SOIL PRESSURE, 350 PCF PASSIVE PRESSURE, 0.35 COEFFICIENT OF FRICTION ALL FOOTINGS AND SLABS SHALL BEAR ON UNDISTURBED SOIL OR FILL COMPACTED TO 95% MODIFIED
- 3000 PSI @ 28 DAYS (2500 PSI USED FOR DESIGN) 7. CONCRETE: **GRADE 40 REINFORCEMENT**
 - MINIMUM 3" COVER FOR ALL REINFORCEMENT EXCEPT AS NOTED AT RETAINING WALLS OR OTHER


TIMBER CONSTRUCTION NOTES

- 1. LUMBER GRADES AND ALLOWABLE STRESSES SHALL BE AS FOLLOWS UNLESS NOTED OTHERWISE ON PLAN:
- HF#2 OR BETTER, ALL SAWN LUMBER Fb = 875 PSI, Fv = 75 PSI, E = 1,300,000
- 24F-V4, Fb = 2400 PSi, Fv = 165 PSi, E = 1,800,000 **GLULAM BEAMS** Fb = 2600 PSI, Fv = 285 PSI, E = 1,900,000 MICROLAM, LVL
- Fb = 2600 PSI, Fv = 290 PSI, E = 2,000,000 PARALLAMS, PSL 2. WHEN TOP PLATE IS INTERRUPTED BY HEADER, HEADER SHALL HAVE STRAP CONNECTORS TO THE TOP PLATE EACH END,
- USE 2-SIMPSON MSTA24 CONNECTORS, UNLESS NOTED OTHERWISE. 3. ALL SHEAR WALL SHEATHING NAILS AND ANCHORS SHALL BE AS DETAILED ON THE DRAWINGS AND AS NOTED IN THE
- 4. FLOOR SHEATHING SHALL BE ¾" MINIMUM APA RATED FLOOR SHEATHING WITH 10d COMMON @ 6" OC AT ALL SUPPORTED
- PANEL EDGES AND 10d @ 12" OC AT INTERMEDIATE SUPPORTS. 5. ROOF SHEATHING SHALL BE 7/16" MINIMUM APA RATED ROOF SHEATHING WITH 8d COMMON @ 6" OC AT ALL SUPPORTED PANEL EDGES AND 8d @ 12" OC AT INTERMEDIATE SUPPORTS.

GENERAL CONSTRUCTION NOTES

- 1. CONTRACTOR SHALL VERIFY ALL DIMENSIONS IN THE FIELD. ANY VARIATIONS FROM THE DRAWINGS SHALL BE BROUGHT TO
- THE ATTENTION OF THE DESIGNER OR THE ENGINEER.
- 2. ADEQUATE SHORING AND BRACING OF ALL STRUCTURAL MEMBERS DURING CONSTRUCTION SHALL BE PROVIDED. ANY PROPOSED FIELD CHANGES MUST HAVE THE APPROVAL OF THE ENGINEER PRIOR TO CONSTRUCTION.

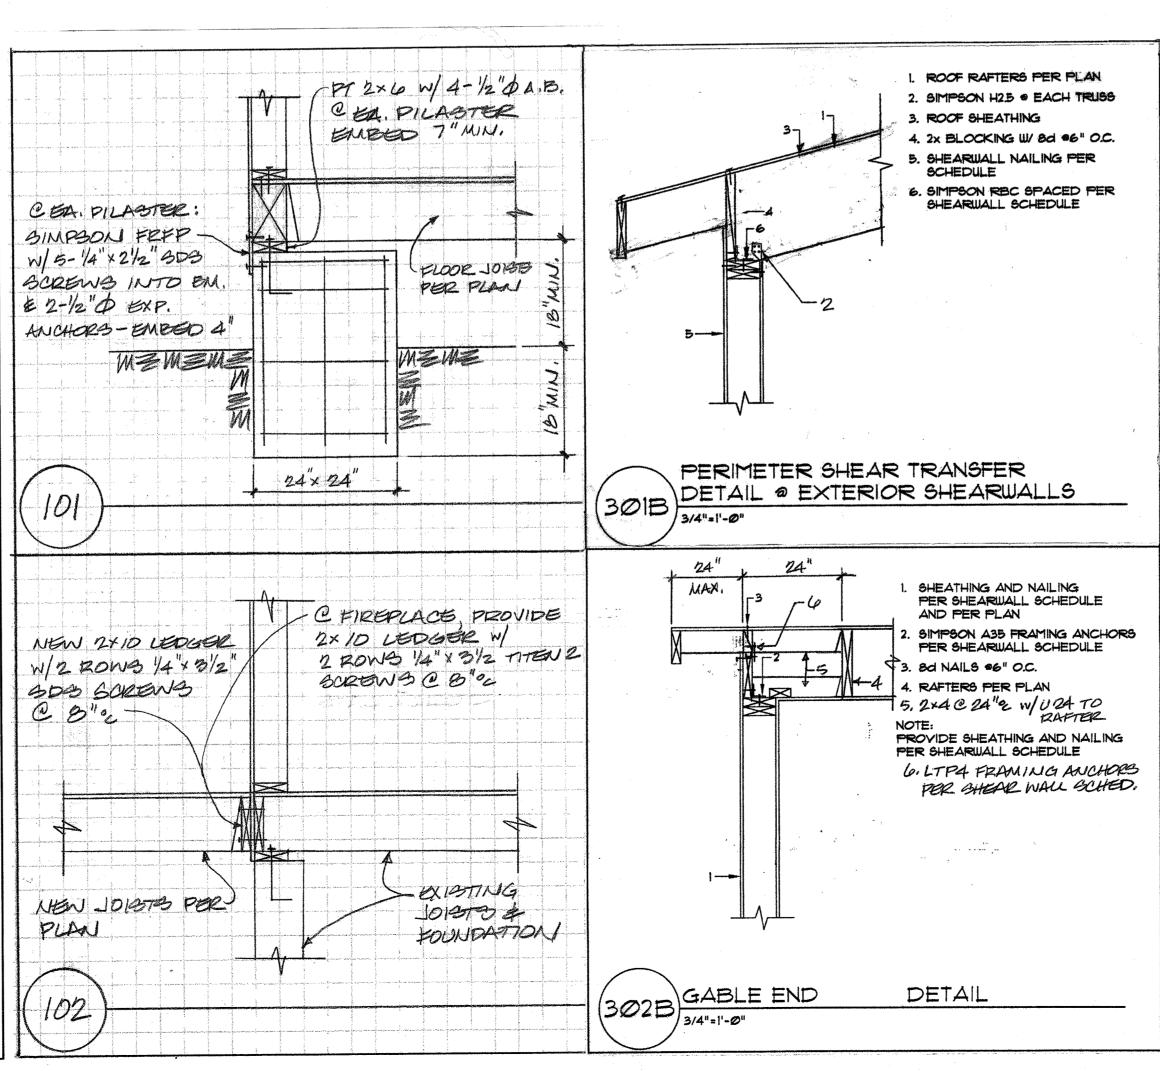

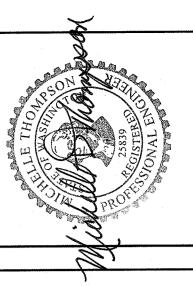

REVISION DATES:

SCALE: DATE: N.T.S. DRAWN BY: SHEET NO. MOT PROJECT, NO. MANER MAIR WENDEL